STATE OF FLORIDA DEPARTMENT OF TRANSPORTATION

CONTRACT PLANS

FINANCIAL PROJECT ID 431962-1-52-01

DUVAL COUNTY (72190)

STATE ROAD NO. 212

INDEX OF LANDSCAPE PLANS

SHEET NO. SHEET DESCRIPTION

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1D-4

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STORM WATER POLLUTION PREVENTION PLAN LD - 51 LD-52 - LD-54 TRAFFIC CONTROL PLAN

MAINTENANCE PLAN

BEGIN PROJECT

STA. 644+45.88

MP. 12.047

TO I-95 T-3-S

GOVERNING STANDARDS AND SPECIFICATIONS: Florida Department of Transportation, 2016 Design Standards and revised Index Drawings as appended herin, and January 2016 Standard Specifications for Road and Bridge Construction, as amended by

For Design Standards click on the "Design Standards" link at the following web site:

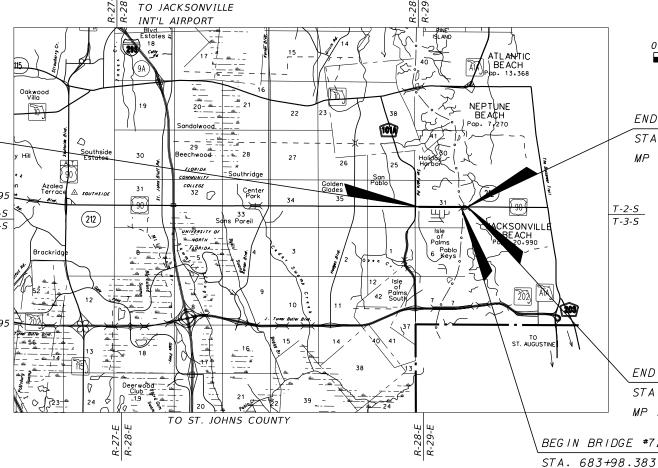
http://www.dot.state.fl.us/rddesign/

Contract Documents.

For the Standard Specifications for Road and Bridge Construction click on the "Specifications" link at the following

http://www.dot.state.fl.us/specificationsoffice/

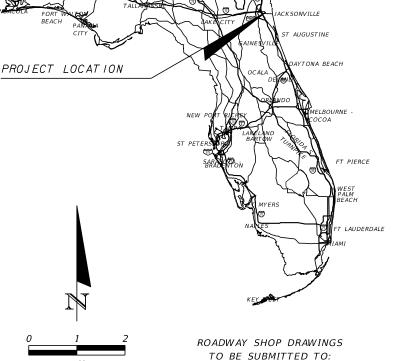
LANDS CAPE PLANS



PROJECT LENGTH IS BASED ON C/L OF SR 212 BEACH BOULEVARD

LENGTH (OF PROJE	CT
	LINEAR FEET	MILES
ROADWAY	9149.561	1.733
BRIDGES	2297 . 479	0.435
NET LENGTH OF PROJECT	11447.040	2.168
EXCEPTIONS	0.000	0.00
GROSS LENGTH OF PROJECT	11447.040	2.168

FDOT PROJECT MANAGER: AMY L. WILLIAMS



Shawn Bliss, R.L.A. NO. 1548 Prosser, Inc.

13901 Sutton Park Drive So., Ste. 200 Jacksonville, Florida 32224-0229 p: 904.739.3655 f: 904.730.3413 e: info@prosserinc.com

Fla. Certificate of Authorization No.: 00004050 Consultant Contract No.: C9870 Vendor No.: F592484852-001

PLANS PREPARED BY:

Prosser, Inc.

13901 Sutton Park Drive So., Ste. 200 Jacksonville, Florida 32224-0229

p: 904.739.3655 f: 904.730.3413 e: info@prosserinc.com Fla. Certificate of Authorization No.: 00004050 Consultant Contract No.: C9870 Vendor No.: F592484852-001

NOTE: THE SCALE OF THESE PLANS MAY HAVE CHANGED DUE TO REPRODUCTION.

END BRIDGE #720730 STA. 706+95.63

MP 13.231

END PROJECT

MP 14.215

STA. 758+92.92

BEGIN BRIDGE #720730

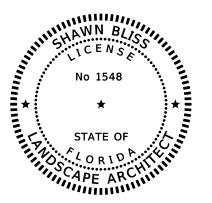
MP 12.796

SHEET REVISIONS
DESCRIPTION

LANDSCAPE PLANS ARCHITECT OF RECORD: SHAWN BLISS, R.L.A.

R.L.A. NO.: 1548

FISCAL YEAR	SHEET NO.
16	LD-1



THIS DOCUMENT HAS BEEN DIGITALLY SIGNED AND SEALED BY:

PRINTED COPIES OF THIS DOCUMENT ARE NOT CONSIDERED SIGNED AND SEALED. THE SIGNATURE MUST BE VERIFIED ON THE ELECTRONIC DOCUMENTS.

PROSSER, INC. 13901 SUTTON PARK DRIVE SOUTH, SUITE 200 JACKSONVILLE, FL 32224

THE ABOVE NAMED PROFESSIONAL LANDSCAPE ARCHITECT SHALL BE RESPONSIBLE FOR THE FOLLOWING SHEETS IN ACCORDANCE WITH RULE 61G10-11.011, F.A.C.

LANDSCAPE PLANS

SHEET NO. SHEET DESCRIPTION LD-1 REY SHEET
SIGNATURE SHEET
SUMMARY OF PAY ITEMS
TABULATION OF QUANTITIES AND PLANT SCHEDULE
TABULATION OF QUANTITIES AND IRRIGATION SCHEDULE
TABULATION OF QUANTITIES
LANDSCAPE DETAILS
LANDSCAPE GENERAL NOTES LD-3 LD-4 LD-5 LD-6 - LD-7 LD-8 LD-9 LD-10 PROJECT LAYOUT LD-11 PROJECT NOTES LD-12 - LD-29 LANDSCAPE PLAN LD-55 MAINTENANCE PLAN



THIS DOCUMENT HAS BEEN DIGITALLY SIGNED AND SEALED BY:

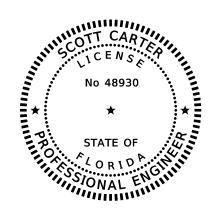
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JANET O. WHITMILL, R.L.A., INC. P.O. BOX 5212 JACKSONVILLE, FL 32247-5212

THE ABOVE NAMED PROFESSIONAL LANDSCAPE ARCHITECT SHALL BE RESPONSIBLE FOR THE FOLLOWING SHEETS IN ACCORDANCE WITH RULE 61G10-11.011, F.A.C.

LANDSCAPE PLANS

SHEET NO. SHEET DESCRIPTION LD-30 - LD-32 **IRRIGATION DETAILS** LD-33 - LD-50 IRRIGATION PLAN



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13901 SUTTON PARK DRIVE SOUTH, SUITE 200 JACKSONVILLE, FL 32224

THE ABOVE NAMED PROFESSIONAL LANDSCAPE ARCHITECT SHALL BE RESPONSIBLE FOR THE FOLLOWING SHEETS IN ACCORDANCE WITH RULE 61G15-23.004, F.A.C.

LANDSCAPE PLANS

SHEET NO. SHEET DESCRIPTION

LD-51 LD-52 - LD-54 STORM WATER POLLUTION PREVENTION PLAN

TRAFFIC CONTROL PLAN

	REVIS	IONS		SHAWN BLISS, R.L.A.		STATE OF F	LORIDA	
DATE	DESCRIPTION	DATE	DESCRIPTION	R.L.A. NO.: 1548	DFD	ARTMENT OF TRA		i
				PROSSER, INC.	DIAT	inipidia or invi	INDICKIALION	i
				13901 SUTTON PARK DRIVE SOUTH,	ROAD NO.	COUNTY	FINANCIAL PROJECT ID	
				SUITE 200				i
				JACKSONVILLE, FL 32224	SR 212	DUV AL	431962-1-52-01	1
				CERTIFICATE OF AUTHORIZATION: 00004050				ı

SIGNATURE SHEET

SHEET NO.

03/18/2016 16:01:27 PM

								03/18/2	016 16:01	:2/ PM
			PROJ	ECT SUMMA	NT OF TRAN ARY OF PAY 431962-1					
LEAL	O PRO	IECT : 431962-	1 - 52 - 01	DISTRIC	Г : 02		C	OUNTY/SECTIO	ON : 72190	0000
PRO.	JECT (S	5) : 4319621520	01		COUNTY :	DUVAL				
			0600 SUMM	IARY OF LA	ANDSCAPE /	PERIPHERAL				
SPC	ALT	ITEM NUMBER	IT	EM DESCRI	PTION		UNIT	43196215201	QUANT ITY	TOTAL
		0999- 2-	LUMP SUM CONTRACT, ALTER	NATIVE B	I DD I NG		LS	1.000		1.000
		0999- 25-	INITIAL CONTINGENCY AMOU	INT , DO NO	OT BID		LS	1.000 N		1.000

PAY ITEM NOTES:

1. 999-2 LUMP SUM CONTRACT: ALL OTHER PAY ITEM NUMBERS SHOWN IN THE CONTRACT PLANS ARE PROVIDED ONLY FOR THE PURPOSE OF DESCRIBING THE WORK TO BE PERFORMED. PAY ITEM DESCRIPTIONS ARE FOUND IN THE DEPARTMENT'S BASIS OF ESTIMATES MANUAL.

	REVI:	SIONS		SHAWN BLISS, R.L.A.		STATE OF FL	CORTO 4
DATE	DESCRIPTION	DATE	DESCRIPTION	R.L.A. NO.: 1548 PROSSER, INC.	DEP_{2}	STATE OF FL ARTMENT OF TRAN	
				13901 SUTTON PARK DRIVE SOUTH,	ROAD NO.	COUNTY	FINANCIAL PROJECT ID
				SUITE 200 JACKSONVILLE, FL 32224 CERTIFICATE OF AUTHORIZATION: 00004050	212	DUVAL	431962-1-52-01

SUMMARY OF PAY ITEMS

SHEET NO.

PAY ITEM	SYM	BOTANICAL NAME	COMMON NAME	INSTALLED	MAXIMUM MAINTA	SPACING	REMARKS	UNI	r L					NUMBER.					
NO.	31 M	BOTANTCAL NAME	COMMON NAME	SIZE	INED SIZE	3FACTNO	NEMANNS	ONT	LI	D-12 1 FINAL	LD-13 PLAN FINAL		- 14 FINAL	LD-		LD-		LD-	
									I LAI	V T TWAL	T LAN T INAL	LAN	TINAL	LAN	TINAL	LAN	TINAL	1 LAN	IIIVAL
0580-1-2		LANDSCAPE COMPLETE- LARGE PLANTS	MEDJOOL DATE	23 FT. C.T. X 20 FT. SPRD.;							_	_				_			
	PD	PHOENIX DACTYLIFERA 'MEDIJOOL'	PALM	MATCHED HT'S	NATURAL	SEE PLAN	CLASSIC CUT LEAF BASES	EA			6	2				1		17	
	PS	PHOENIX SYLVESTRIS	WILD DATE PALM	16 FT. C.T. X 18 FT SPRD.; MATCHED HT'S	NATURAL	SEE PLAN	STRAIGHT CUT LEAF BASES	EA	3			6		3					
	QV	QUERCUS VIRGINIANA 'SLDN' PP12015 CATHEDRAL	CATHEDRAL OAK	15 FT. X 7 FT. SPRD., 4" CALP.	NATURAL	SEE PLAN	5 FT. C.T. MIN.	EA											
	SP	SABAL PALMETTO	CABBAGE PALM	12 FT. C.T 18 FT C.T.	NATURAL	SEE PLAN	EQUAL QTY'S OF EA. SIZE FOR . (12:,15:,18' C.T.) HT'S, NO ADJAC SAME HT; SLICK TRUNK; ROOT REGENERATED-THREE (3) EXCE LEAVES MIN.	ENT PALMS EA				11				20			
	SP-R	RELOCATED SABAL PALMETTO	CABBAGE PALM	EXISTING - HT.'S VARY	NATURAL	SEE PLAN	EXISTING PALMS TO BE DUG AN RELOCATED, FROND BOOTS TO F PROTECT FROM DAMAGE												
0580-1-1		LANDSCAPE COMPLETE- SMALL PLANTS	EVERGREEN			71.00	5000 5000 5000 500									150			
	PQ	PASPALUM QUADRIFARIUM	PASPALUM	3 GAL, 16 IN. HT. X 16 IN. SPRD.	NATURAL	3' O.C.	FULL DENSE FOLIAGE	EA				77				158			
	SOD	PERFORMANCE TURF - CYNODON SPP 'COMMON'	COMMON BERMUDA	SOLID SOD PIECES	N/A	N/A	MAINTAIN PER FDOT MAINT. RAT PROGRAM	TING SY	559		862	1148		1157		578		1790	
D 4)/					MAX I MUM								HEET	NUMBER.	<u> </u>				
ITEM NO.	SYM	BOTANICAL NAME	COMMON NAME	INSTALLED SIZE	MAINTA INED	SPACING	REMARKS	UNI	r	D - 18	LD-19		- 20	LD-		LD-	- 22	LD-	23
<i>NO</i> .					SIZE						PLAN FINAL								
0580-1-2		LANDSCAPE COMPLETE- LARGE PLANTS																	
	PD	PHOENIX DACTYLIFERA 'MEDIJOOL'	MEDJOOL DATE PALM	23 FT. C.T. X 20 FT. SPRD.; MATCHED HT'S	NATURAL	SEE PLAN	CLASSIC CUT LEAF BASES	EA						6		4			
	PS	PHOENIX SYLVESTRIS	WILD DATE PALM	16 FT. C.T. X 18 FT SPRD.; MATCHED HT'S	NATURAL	SEE PLAN	STRAIGHT CUT LEAF BASES	EA											
	QV	QUERCUS VIRGINIANA 'SLDN' PP12015 CATHEDRAL	CATHEDRAL OAK	15 FT. X 7 FT. SPRD., 4" CALP.	NATURAL	SEE PLAN	5 FT. C.T. MIN.	EA				3							
	SP	SABAL PALMETTO	CABBAGE PALM	12 FT. C.T 18 FT C.T.	NATURAL	SEE PLAN	EQUAL QTY'S OF EA. SIZE FOR: (12',15',18' C.T.) HT'S, NO ADJAC SAME HT; SLICK TRUNK; ROOT REGENERATED-THREE (3) EXCE LEAVES MIN.	ENT PALMS EA						20		19		33	
	SP-R	RELOCATED SABAL PALMETTO	CABBAGE PALM	EXISTING - HT!S VARY	NATURAL	SEE PLAN	EXISTING PALMS TO BE DUG AN RELOCATED, FROND BOOTS TO F PROTECT FROM DAMAGE.					73		21					
580-1-1		LANDSCAPE COMPLETE- SMALL PLANTS	EVERGREEN																
	PQ	PASPALUM QUADRIFARIUM	PASPALUM	3 GAL, 16 IN. HT. X 16 IN. SPRD.	NATURAL	3' O.C.	FULL DENSE FOLIAGE	EA						160		97		167	
	50D	PERFORMANCE TURF - CYNODON SPP 'COMMON'	COMMON BERMUDA	SOLID SOD PIECES	N/A	N/A	MAINTAIN PER FDOT MAINT. RAI PROGRAM	TING SY						963		1077		601	
																			_
PAY ITEM	SYM	BOTANICAL NAME	COMMON NAME	INSTALLED	MAXIMUM MAINTA	SPACING	REMARKS	UNI	, L					NUMBER					
NO.				SIZE	INED SIZE				L	D-24 N FINAL	LD-25 PLAN FINAL		- 26 F I NAL	LD-		LD-		LD- PLAN	
0580-1-2		LANDSCAPE COMPLETE- LARGE PLANTS																	
9300-1-2	PD	PHOENIX DACTYLIFERA 'MEDIJOOL'	MEDJOOL DATE PALM	23 FT. C.T. X 20 FT. SPRD.; MATCHED HT'S	NATURAL	SEE PLAN	CLASSIC CUT LEAF BASES	EA	5					3					
	PS	PHOENIX SYLVESTRIS	WILD DATE PALM	16 FT. C.T. X 18 FT SPRD.; MATCHED HT'S	NATURAL	SEE PLAN	STRAIGHT CUT LEAF BASES	EA			4	13						1	
	QV	QUERCUS VIRGINIANA 'SLDN' PP12015 CATHEDRAL	CATHEDRAL OAK	15 FT. X 7 FT. SPRD., 4" CALP.	NATURAL	SEE PLAN	5 FT. C.T. MIN.	EA										i	
	SP	SABAL PALMETTO	CABBAGE PALM	12 FT. C.T 18 FT C.T.	NATURAL	SEE PLAN	EQUAL QTY'S OF EA. SIZE FOR. (12',15',18' C.T.) HT'S, NO ADJAC SAME HT; SLICK TRUNK; ROOT REGENERATED-THREE (3) EXCE LEAVES MIN.	ENT PALMS EA	37		4			26		3			
	SP-R	RELOCATED SABAL PALMETTO	CABBAGE PALM	EXISTING - HT.'S VARY	NATURAL	SEE PLAN	EXISTING PALMS TO BE DUG AN	D REMAIN, EA											1
0580-1-1	PO	LANDSCAPE COMPLETE- SMALL PLANTS PASPALUM QUADRIFARIUM	EVERGREEN	3 GAL, 16 IN. HT. X 16 IN. SPRD.	NATURAL	3' O.C.	FULL DENSE FOLIAGE	EA	221		20			116		22			_
			PASPALUM	3 6/L, 10 M. M. A 10 M. 3/AD.	7777 077712	3 0.0.								110					
	SOD	PERFORMANCE TURF - CYNODON SPP 'COMMON'	COMMON BERMUDA	SOLID SOD PIECES	N/A	N/A	MAINTAIN PER FDOT MAINT. RA' PROGRAM	ING SY	1070		520	905		640		154			
		REVISIONS	1	1	SHAWN BI				STA	TE OF	FLORIDA	-	' T				1		_
	DESC	RIPTION DATE	Di	ESCRIPTION	R.L.A. NO.: PROSSER,			DEPART			ANS PORTATI	!ON		TAI	RITI.	A TI		OF	0

LEGEND:

A.G. C.T. FT. IN. N/A O.C. SPRD.

ABOVE GRADE
CLEAR TRUNK
FEET
INCH
NOT APPLICABLE
ON CENTER
SPREAD

NTITIES DULE

SHEET NO.

TAI	BULATIC	ON OF QUANTITIES AND SCHEDULE FOR IRRIGATION
QUANT ITY	UNIT	DESCRIPTION
1	LS	IRRIGATION PIPE, BUBBLERS, DRIPLINE, DIRECTIONAL BORE PIPE, ISOLATION VALVES AND ASSOCIATED EQUPMENT
1	LS	REMOTE CONTROL VALVES WITH PRESSURE REGULATOR
1	LS	IRRIGATION CONTROLLERS - 4 STATION WITH RAIN AND FREEZE SWITCH
1	LS	POTABLE WATER METER WITH BACKFLOW PREVENTER
1	LS	RECLAIMED WATER METER INSTALLATION

	RE\	ISIONS .		SHAWN BLISS, R.L.A.		STATE OF F	LORIDA
DATE	DESCRIPTION	DATE	DESCRIPTION	R.L.A. NO.: 1548	DED.	ARTMENT OF TRAI	
				PROSSER, INC.	101111	11(11/12)111 01 11(11	401 OM 1211 HO14
				13901 SUTTON PARK DRIVE SOUTH,	ROAD NO.	COUNTY	FINANCIAL PROJECT IL
				SUITE 200			
				JACKSONVILLE, FL 32224	SR 212	DUVAL	431962-1-52-01
				CERTIFICATE OF AUTHORIZATION: 00004050			

TABULATION OF QUANTITIES AND IRRIGATION SCHEDULE

	SUMMARY O	F LUMP	SUM I	TEMS	
PAY ITEM NO.	PAY ITEM DESCRIPTION	QUAN P	T ITY F	DESIGN NOTES	CONSTRUCTION REMARKS
101-1	MOBILIZATION	1			

		SUMM	ARY OF T	TEMPORAR	Y TRAF	FIC CON	TROL PLA	N ITEM	S			
PAY ITEM	DAY ITEM DESCRIPTION	UNIT		PHASE I		PHASE II			TOTAL		DESIGN	CONSTRUCT I ON
NO.			DURAT I ON	QUANT ITY	TOTAL	DURAT I ON	QUANT ITY	TOTAL			NOTES	REMARKS
			DAYS	P	Р	DAYS	P	Р	Р	F	1	
102-1	MAINTENANCE OF TRAFFIC	LS	1	1	1			0	1			
102-60	WORK ZONE SIGN	ED	155	32	4960			0	4960			
102-74-1	CHANNELIZING DEVICE- TYPES I, II, DI, VP, DRUM, OR LCD	ED	155	142	22010			0	22010			
102-76	ARROW BOARD/ADVANCE WARNING ARROW PANEL	ED	155	2	310			0	310			
102-99	PORTABLE CHANGEABLE MESSAGE SIGN, TEMPORARY	ED	155	2	310			0	310			
					0			0	0			
					0			0	0			

								SUMMA	RY OF	EROSION	AND	SEDII	MENT C	ONTROL	DEV	ICES					
LOC	CATION		AREA	ART I F COVE F		SEDIM BASI		SEDI BAS CLEA	SIN	SEDIME. BARRIE		F L O A T U R B . B A R F	IDITY	STAKE TURBID BARRI	ITY	SOIL TRACKING PREVENTION DEVICE 0104 15	PROTE	LET CTION TEM	DESIGN	CONSTRUCTION	
		SIDE	ID	0104	1 1	0104	7	010	4 9	0104 10	3	010	4 11	0104	12		0104 15	0104 15	010	4 18	NOTES
STA.	TO STA.			S	Υ	EA		E	A	LF		L	F	LF		EA	Ε	A			
				Р	F	Р	F	P	F	P	F	Р	F	Р	F	P F	Р	F			
644+50.00	758+90.00																74				
647+85.00	650+25.00									487.0											
650+40.00	655+90.00						·			1114.0		·	·				·				
656+83.00	660+65.00									789.0											
660+80.00	665+08.00									872.0											
665+20.00	668+23.00									615.0											
668+41.00	669+47.00									243.0											
669+61.00	671+25.00									341.0											
672+28.00	673+65.00									276.0											
674+63.00	683+98.38									1896.0											
699+15.00	713+00.00									3046.0											
706+95.63	712+10.00									1062.0											
712+21.00	713+64.00									304.0											
713+68.00	722+30.00									1717.0											
723+32.00	733+17.00									1967.0											
733+22.00	733+55.00									81.0											
733+63.00	736+45.00									570.0											
738+50.00	745+25.00									1394.0											
746+62.00	753+40.00									1370.0											
		SUI	B-TOTAL:	0.0	0.0	0	0	0	0	18144.0	0.0	0.0	0.0	0.0	0.0	0 0 0	74	0			
			TOTAL:	0	0	0	0	0	0	18144	0	0	0	0	(0 0 0	74	0			

		REVISIONS		SHAWN BLISS, R.L.A.
DATE	DESCRIPTION	DATE	DESCRIPTION	R.L.A. NO.: 1548
				PROSSER, INC.
				13901 SUTTON PARK DRIVE SOUTH,
				SUITE 200
				JACKSONVILLE, FL 32224
				CERTIFICATE OF AUTHORIZATION: 00004050

STATE OF FLORIDA DEPARTMENT OF TRANSPORTATION ROAD NO. COUNTY FINANCIAL PROJECT ID SR 212 DUVAL 431962-1-52-01

TABULATION OF QUANTITIES

SHEET NO.

	SUMMARY OF LITTER REMOVAL AND MOWING												
				LITTER	REMOV A	\L		МОМ	ING				
CONST.	DURAT I ON	FREQUENCY		010				010			DESIGN	CONSTRUCTION	
PHASE	(DAYS)	(DAYS)	(DAYS)	CYCLE	100	AREA TOTA	L (AC)	CYCLE	AC/	AREA TOTA	L (AC)	NOTES	REMARKS
			5	AC / CYCLE	P	F	5	CYCLE	P	F			
INSTALL	155	30	6	24.00	144.00		6	21.00	126.00		INSTALLATION PERIOD		
							0.00						
PLANT EST.	730	30	24	24.00	576.00		24	21.00	504.00		2-YEAR ESTABLISHMENT PERIOD		
		SU	B-TOTAL:		720		5	UB-TOTAL:	630				
			TOTAL:					TOTAL:				0.00	

							JMMAR)	Y OF R	REMOVAL ITEMS						
PAY PAY ITEM ITEM DESCRIPTION		LOCA	T I ON	SIDE	AREA I D	ENGTH	WIDTH	UNITS	SECONDARY UNITS (IF LUMP SUM)		QUANTITY		ΓAL	DESIGN NOTES	CONSTRUCTION REMARKS
NO .		STA. T	O STA.			37	M		AREA (SY)	Р	F	P	F		
10 - 1 - 1	CLEARING & GRUBBING	647+85.00 L	650+25.00 R						516.000					EXISTING TURF	
		650+40.00 R	650+75.00 R						43.000					EXISTING TURF	
		650+75.00 R	655+90.00 L						773.000					EXISTING TURF & TREES	
		656+83.00 R	657+50.00 R						89.000					EXISTING TURF	
		657+50.00 R	660+65.00 L						629.000					EXISTING TURF & TREES	
		660+80.00 R	664+25.30 L						585.000					EXISTING TURF & TREES	
		664+25.00 L	665+8.00 R						209.000					EXISTING TURF & TREES	
		665+20.00 L	668+23.00 L						498.000					EXISTING TURF & TREES	
		668+41.00 R	669+47.00 L						253.000					EXISTING TURF	
		669+61.00 R	671+00.00 R						197.000					EXISTING TURF & TREES	
		671+00.00 R	671+25.00 R						19.000					EXISTING TURF	
		672+28.00 L	673+65.00 L						163.000					EXISTING TURF	
		674+63.00 R	677+75.00 L						533.000					EXISTING TURF	
		677+75.00 L	683+98.38 L						1790.000					EXISTING TURF & TREES	
		706+95.63 L	771+50.00 L						1102.000					EXISTING TURF & TREES	
		711+50.00 L	712+10.00 L						67.000					EXISTING TURF	
		712+21.00 L	713+64.00 L						317.000					EXISTING TURF	
		713+68.00 L	718+25.00 R						777.000					EXISTING TURF & TREES	
		718+25.00 R	722+30.00 R						535.000					EXISTING TURF & TREES	
		723+32.00 R	725+00.00 R						209.000					EXISTING TURF & TREES	
		725+00.00 R	731+75.00 R						1261.000					EXISTING TURF & TREES	
		731+75.00 R	733+17.00 R						174.000					EXISTING TURF & TREES	
		733+22.00 R	733+55.00 R						24.000					EXISTING TURF	
		733+63.00 R	736+45.00 R						340.000					EXISTING TURF & TREES	
		738+50.00 R	745+25.00 R						905.000					EXISTING TURF & TREES	
		746+62.00 R	752+00.00 R						764.000					EXISTING TURF & TREES	
		752+00.00 R	753+40.00 R						173.000					EXISTING TURF	

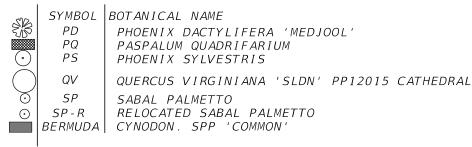
-	REVI	SIONS		SHAWN BLISS, R.L.A.	STATE OF FLORIDA				
DA	ATE DESCRIPTION	DATE	DESCRIPTION	ROSSER, INC.	RTMENT OF TRANSPORTATION				
				13901 SUTTON PARK DRIVE SOUTH,	ROAD NO.	COUNTY	FINANCIAL PROJECT ID		
				SUITE 200 JACKSONVILLE, FL 32224 CERTIFICATE OF AUTHORIZATION: 00004050	SR 212	DUVAL	431962-1-52-01		

TABULATION OF QUANTITIES

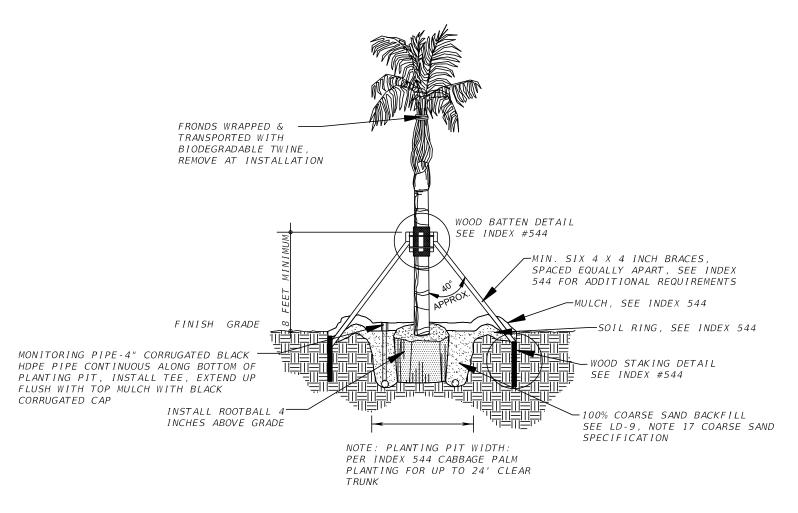
NO.

16 0.22.23

LEGEND:



DATE PALM PLANTING DETAIL TO BE USED WITH INDEX 544



PHOENIX DATE PALM BRACING NOT TO SCALE

		REV	SIONS		SHAWN BLISS, R.L.A.		LORIDA		
F	DATE	DESCRIPTION	DATE	DESCRIPTION	R.L.A. NO.: 1548 PROSSER, INC.	DEP_{A}	DEPARTMENT OF TRANSPORTATION		
					13901 SUTTON PARK DRIVE SOUTH,	ROAD NO.	COUNTY	FINANCIAL PROJECT ID	
					SUITE 200 JACKSONVILLE, FL 32224 CERTIFICATE OF AUTHORIZATION: 00004050	SR 212	DUV AL	431962-1-52-01	

LANDSCAPE DETAILS SHEET

LD-8

SHEET NO.

P:\112\112041-01-5R 212 LANDSCAPE\CADD\CU

ALL PLANT MATERIALS SHALL BE LAID OUT IN THE FIELD A MINIMUM OF 1 WEEK PRIOR TO INSTALLATION OR AS APPROVED BY THE ENGINEER FOR REVIEW. CONTACT SUNSHINE STATE ONE-CALL AS REQUIRED BY CHAPTER 556 OF THE FLORIDA STATUTES PRIOR TO EXCAVATION OR PLANTING. NOTIFY THE ENGINEER OF ANY POSSIBLE CONFLICTS BETWEEN THE PROPOSED PLANTING LAYOUTS AND UTILITIES, BILLBOARDS, SIGNS OR OTHER STRUCTURES

2 PLANT SUPPLEMENTS

ALL PLANT MATERIAL AND PALMS SHALL BE FERTILIZED WITH A 12 MONTH SLOW RELEASE TOP DRESSING FERTILIZER WITH A MINOR ELEMENT PACKAGE TO INCLUDE (BUT NOT LIMITED TO) CALCIUM, MAGNESIUM, SULFUR, IRON, COPPER. MANGANESE. MOLYBDENUM. ZINC AND BORON

ALL PLANT MATERIALS SHALL BE FERTILIZED AT THE TIME OF PLANTING AND 30 DAYS PRIOR TO COMPLETION OF THE ESTABLISHEMENT PERIOD. NOTIFY THE ENGINEER IN WRITING 48 HOURS IN ADVANCE OF ALL FERTILIZER

3. HERBICIDE REQUIREMENT

ALL PRE AND POST HERBICIDAL TREATMENTS SHALL INCLUDE A TEMPORARY TRACER DYE IDENTIFIABLE FOR A MINIMUM OF 2 DAYS AFTER APPLICATION.

BALLED AND BURLAPPED MATERIALS ARE TO BE ROOTED AND GROWN IN SIMILAR PLANTING
MEDIUM AS THE SOIL CONDITIONS OF THE PROPOSED LOCATION. CLAY SOIL ROOT BALLS WILL
NOT BE ACCEPTED AS SUITABLE PLANTING MEDIUM IN BALLED AND BURLAPPED PLANT MATERIAL.

ALL BALLED AND BURLAPPED MATERIALS SHALL EXHIBIT WHITE FEEDER ROOTS PROTRUDING FROM THE BURLAP AT THE TIME OF DELIVERY.

5. PLANT CONDITIONS PLANTS THAT CALL OUT FOR A CENTRAL LEADER SHALL NOT HAVE PRESENCE OR PAST EVIDENCE OF A CENTRAL LEADER BEING PRUNED LARGER THAN A STANDARD PENCIL DIAMETER.

ALL PLANTS SHALL NOT DEMONSTRATE SIGNIFICANT EVIDENCE OF PREVIOUS CONTAINER CONFINEMENT. ANY INDICATION OF ROOT DEVELOPMENT RESTRICTION OR EXCESSIVE ROOTS EXPOSED ABOVE THE SOIL SURFACE SHALL BE GROUNDS FOR REJECTION

ALL PLANT MATERIALS SHALL HAVE NO LICHENS, ALGAE OR FUNGI ATTACHED ON MORE THAN 10% OF PLANT.

ALL PLANT MATERIALS SHALL HAVE NO SPANISH MOSS (TILLANDSIA USNEOIDES) ON OR WITHIN PLANT CANOPY.

NON-BIODEGRADABLE BACKING MAY HAVE BEEN UTILIZED ON EXISTING SOD. NO ADDITIONAL PAYMENT WILL BE MADE FOR ANY AND ALL EXCAVATION COSTS ASSOCIATED

REGRADE AND/OR REPLACE ANY SOD THAT IS DISTURBED BY THE LANDSCAPE PROJECT SUCH AS RUTTING OR TRENCHING. ALL RESTORATION OF DISTURBED AREAS SHALL BE PERFORMED WITH BERMUDA SOD UNLESS OTHERWISE DIRECTED BY THE ENGINEER; NO ADDITIONAL PAYMENT WILL BE MADE.

INSTALL TEMPORARY IRRIGATION SYSTEM PRIOR TO INSTALLING PLANT MATERIALS. PLANT MATERIALS SHALL BE SYSTEMATICALLY IRRIGATED WITHIN 48 HOURS OF PLANTING.

DURING THE PROJECT CONSTRUCTION PERIOD AND ESTABLISHMENT PERIOD, KEEP THE INDIVIDUAL PLANTING LOCATIONS, PLANTING BEDS AND TURF AREAS FREE OF LITTER AND UNDESIRABLE VEGETATION.

REMOVE ALL STAKING AND GUYING AT THE END OF THE ESTABLISHMENT PERIOD

MOW ENTIRE PROJECT LIMITS DURING THE CONTRACT AND ESTABLISHMENT PERIOD.

TRIM ALL TREES AS INDICATED ON THE CONTRACT DOCUMENTS. TRIM LOWER BRANCHES ONLY.
ALL TRIMMING SHALL BE PERFORMED TO RAISE EXISTING TREE CANOPY TO MINIMUM OF 5'
FROM GROUND LEVEL. TRIMMING SHALL BE PERFORMED PER INTERNATIONAL SOCIETY OF ARBORICULTURE (ISA) STANDARDS. ALL TRIMMING WORK SHALL BE EXECUTED PRIOR TO START OF THE ESTABLISHMENT PERIOD.

PROVIDE 48 HOURS ADVANCE NOTICE OF DELIVERY OF PLANT MATERIALS FOR INSPECTION.

MAINTAIN A 3 INCH MULCH COVER DURING INSTALLATION AND DURING THE PLANT ESTABLISHMENT PERIOD.

14. THIS PROJECT IS WITHIN THE LIMITS OF THE DEPARTMENT'S PHASE 1 - NPDES PERMIT. PART OF THE PERMIT REQUIRES CONTRACTORS APPLYING FERTILIZER TO BE TRAINED THROUGH THE GREEN INDUSTRY BMP PROGRAM AND TO HAVE OBTAINED LIMITED CERTIFICATION FOR URBAN LANDSCAPING COMMERCIAL FERTILIZER APPLICATION.

15. PLAN DEVIATIONS

INSTALL ROOTBALLS OF TREES AND PALMS A MINIMUM OF 5 FEET FROM UNDERGROUND UTILITIES INSTALL NO MATERIALS THAT WILL BLOCK OR CREATE CONFLICTS WITH:

LIGHTS D) BILLBOARDS

FIRE HYDRANTS

ELECTRIC COMPANIES REQUIREMENTS FOR SETBACKS OF PLANT MATERIALS FROM POWER LINES:

OVERHEAD AND UNDERGROUND STRUCTURES AND UTILITIES;

ANZI Z 133 UTILITY CLEARANCE REQUIREMENTS; AND FDOT MAINTENANCE RATING PROGRAM REQUIREMENTS.

NOTIFICATION OF THE ENGINEER IS REQUIRED WHEN THESE ISSUES ARE ENCOUNTERED, FIELD ADJUSTMENTS REQUIRE APPROVAL BY THE ENGINEER.

16. PLANT MATERIAL RELOCATION

A) NOTIFY THE ENGINEER PRIOR TO BEGINNING ANY PLANT MATERIAL RELOCATION ACTIVITIES

- RELOCATE PLANT MATERIALS FROM THEIR PRESENT LOCATION TO THE LANDSCAPE AREAS NOTED ON THE PLANS.
- TREE NUMBER TAGS PRIOR TO ANY PLANT MATERIAL RELOCATION ACTIVITIES, ATTACH A TAG TO EACH PLANT TO BE RELOCATED WITH A DIFFERENT NUMBER, THE TREE NUMBER TAG SHALL NOT CAUSE INJURY TO THE PLANT MATERIAL. REMOVE TAGS AT THE END OF THE ESTABLISHMENT PERIOD.
- PRUNING SABAL PALMS MAY BE "HURRICANE CUT". FRONDS LEFT ON PALMS SHALL BE TIED UP PRIOR TO TRANSPORT, THEN REMOVED IMMEDIATELY AFTER INSTALLATION.
- ROOT PRUNING SABAL PALMS MAY BE RELOCATED IMMEDIATELY AFTER ROOT PRUNING. ANY ROOT PRUNED PLANT MATERIALS NOT RELOCATED IMMEDIATELY SHALL BE BRACED IN PLACE PER DESIGN DETAILS AND SPECIFICATIONS ROOT PRUNE BY HAND DIGGING, TREE SPADE OR BY TRENCHER WITH ROOT PRUNING SAW ONLY. PRUNE MINIMUM OF 12"
- TRANSPLANTING PLANT MATERIAL RELOCATED PLANT MATERIALS SHALL BE INSTALLED WITHIN 24 HOURS AFTER REMOVAL FROM ORIGINAL LOCATION. INSTALL PLANT MATERIALS IN ACCORDANCE WITH DESIGN STANDARDS AND
- RELOCATED PLANT MATERIALS SHALL RECEIVE SUPPLEMENTAL WATERING TO ENSURE PROPER ROOT REGENERATION AFTER
- RELOCATED PLANT MATERIALS WHICH ARE DEAD, DAMAGED OR HAVE MORE THAN 20% DIEBACK DURING THE ESTABLISHMENT PERIOD SHALL BE REPLACED AT THE CONTRACTOR'S EXPENSE. REPLACEMENT MATERIALS SHALL BE THE SAME SPECIES AND SIZE.

17.SOIL BACKFILL SOIL BACKFILL BY VOLUME FOR PLANT MATERIALS OTHER THAN PHOENIX SPECIES:

50% IMPORTED TOPSOIL - FERTILE, FRIABLE SOIL CONTAINING LESS THAN 5% TOTAL VOLUME OF THE COMBINATION OF SUBSOIL, REFUSE, ROOTS LARGER THAN 1 INCH DIAMETER, HEAVY, STICKY OR STIFF CLAY, STONES LARGER THAN 2 INCHES IN DIAMETER, NOXIOUS SEEDS, STICKS, BRUSH, LITTER, OR ANY SUBSTANCES DELETERIOUS TO PLANT GROWTH. PERCENT (%) OF THE ABOVE OBJECTS CONTROLLED BY SOURCE SELECTION, NOT BY SCREENING THE SOIL. TOPSOIL SUITABLE TO SUPPORT VEGETATIVE GROWTH. NOT CONTAIN WEED SEEDS IN QUANTITIES THAT CAUSE NOTICEABLE WEED INFESTATIONS IN THE FINAL PLANTING BEDS. IMPORTED TOPSOIL TO MEET THE FOLLOWING PHYSICAL AND CHEMICAL CRITERIA:

SOIL TEXTURE: USDA SANDY LOAM.

PH VALUE SHALL BE BETWEEN 5.5 AND 7.0.

PERCENT ORGANIC MATTER (OM): 2.0-5.0%, BY DRY WEIGHT.

SOLUBLE SALT LEVEL: LESS THAN 2 MMHO/CM.

SOIL CHEMISTRY SUITABLE FOR GROWING THE PLANTS SPECIFIED.

HARVESTED FROM FIELDS OR DEVELOPMENT SITES. ORGANIC CONTENT AND PARTICLE SIZE DISTRIBUTION A RESULT OF

NATURAL SOIL FORMATION. MANUFACTURED SOILS WHERE COARSE SAND, COMPOSTED ORGANIC MATERIAL OR CHEMICAL

ADDITIONS OF THE PROPERTY OF THE COLUMN OF THE PROPERTY OF THIS SPECIFICATION SECTION. ADDITIVES HAS BEEN ADDED TO THE SOIL TO MEET THE REQUIREMENTS OF THIS SPECIFICATION SECTION ARE NOT ACCEPT ABLE

SUBMIT SOIL TEST FOR EACH SOURCE UTILIZED.

25% COARSE SAND - CLEAN, WASHED, SAND, FREE OF TOXIC MATERIALS

A) COARSE CONCRETE SAND, ASTM C-33 FINE AGGREGATE, WITH A FINES MODULUS INDEX OF 2.8 AND 3.2.

B) CLEAN, SHARP, NATURAL COARSE SANDS FREE OF LIMESTONE, SHALE AND SLATE PARTICLES. MANUFACTURED COARSE

SAND NOT PERMITTED.

PH BE LOWER THAN 7.0. SAND WITH THE FOLLOWING PARTICLE SIZE DISTRIBUTION:

<u>PERCENT PASSING</u>

<u>SIEVE</u> <u>PERO</u> 3/8 INCH (9.5 MM)....100 NO 4 (4.75 MM)......95-100 NO 8 (2.36 MM) .80 - 100 NO 16 (1.18 MM).. .50-85 NO 50 (.30 MM) 10 - 30 2 - 10 NO 100 (.15 MM) NO 200 (0.75 MM)

25% EXISTING SOIL REMOVE ROCKS, STICKS OR OTHER DELETERIOUS MATERIAL GREATER THAN 1"IN ANY DIRECTION PRIOR TO BACKFILLING. WATER AND TAMP TO REMOVE AIR POCKETS. CONTACT ENGINEER PRIOR TO PLANTING IF EXISTING SOILS CONTAIN EXCESSIVE SAND, CLAY OR OTHER MATERIALS NOT CONDUCIVE TO PROPER PLANT GROWTH.

THIS PROJECT IS WITHIN THE LIMITS OF A PREVIOUS LANDSCAPE AND IRRIGATION INSTALLATION. MODIFY, REPAIR, REMOVE OR CAP EXISTING IRRIGATION AS REQUIRED.

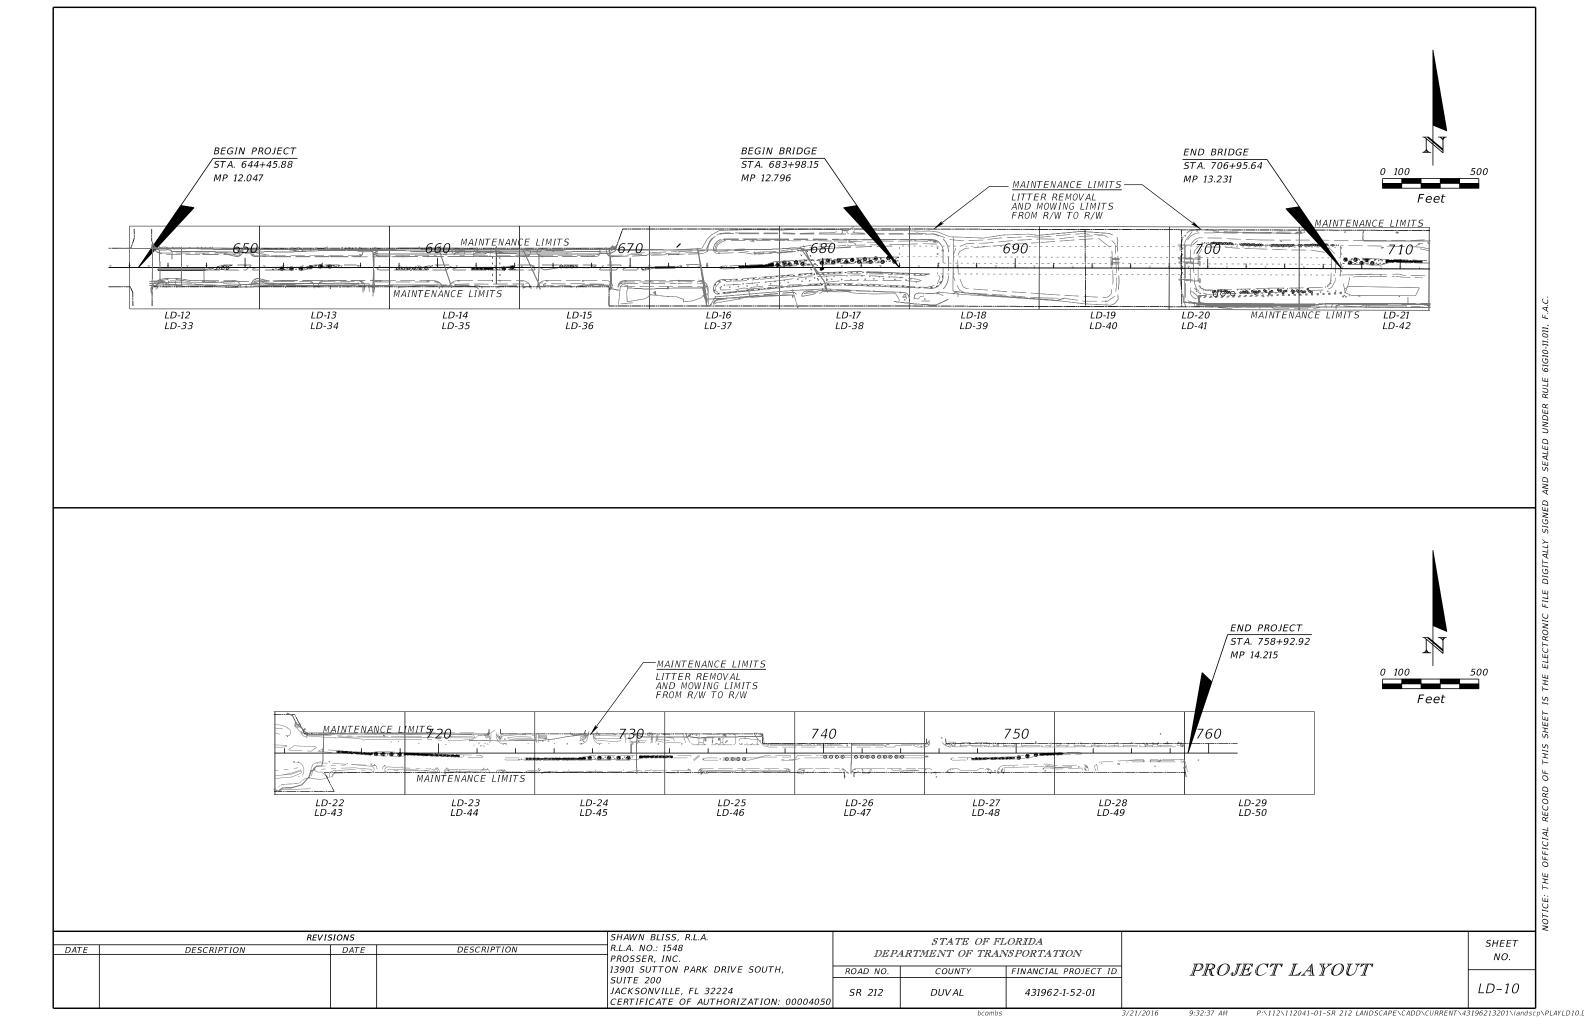
	RE	VISIONS		SHAWN BLISS, R.L.A.	STATE OF FLORIDA			
DATE	DESCRIPTION	DATE	DESCRIPTION	R.L.A. NO.: 1548	DEPARTMENT OF TRANSPORTAT			
				PROSSER, INC.	10131 1	HILITADIVI OI IIL	51 OM121111014	
				13901 SUTTON PARK DRIVE SOUTH,	ROAD NO.	COUNTY	FINANCIAL PROJECT ID	
				SUITE 200				
				JACKSONVILLE, FL 32224	SR 212	DUVAL	431962-1-52-01	
				CERTIFICATE OF AUTHORIZATION: 00004050				

LANDSCAPE GENERAL NOTES

LD-9

SHEET

NO.



- 1. THE LOCATION(S) OF THE UTILITIES SHOWN IN THE PLANS ARE BASED ON LIMITED INVESTIGATION TECHNIQUES AND SHOULD BE CONSIDERED APPROXIMATE ONLY.
- 2. UTILITY/AGENCY OWNERS:

UTILITY OWNERS CONTACT INFORMATION

AT&T FLORIDA
COMCAST
FPL FIBERNET
JEA ELEC/FIBER
JEA W/WW
LEVEL 3904.813.2063
MCI/VERIZON
TECO PEOPLE GAS877.832.6747
CITY OF JACKSONVILLE TRAFFIC904.255.7553
TW TELECOM
CITY OF JAX BEACH
BEACHES ENERGY SERVICES904.247.6241

- 3. IN ACCORDANCE WITH FDOT SPECIFICATIONS 8-6.4, SPECIAL EVENT DAYS FOR THIS PROJECT INCLUDE:
 - A. THURSDAY BEFORE THROUGH THE CLOSE OF TPC GOLF TOURNAMENT
 - B. FRIDAY BEFORE THROUGH THE SUNDAY AFTER THE FLORIDA-GEORGIA GAME
 - C. THE DAY OF THE JAGUAR HOME FOOTBALL GAMES (PRESEASON, REGULAR INCLUDING MONDAY AND THURSDAY NIGHT AND POSTSEASON)
 - D. THE DAY BEFORE THROUGH THE DAY AFTER THE GATOR BOWL
 - E. THE DAY BEFORE THROUGH THE DAY AFTER THE GREATER JACKSONVILLE AGRICULTURAL FAIR
 - F. DONNA HICKEN BREAST CANCER MARATHON
 - G. OPENING WEEKEND AT THE BEACHES
- 4. BILLBOARD OWNERS

CONTACT INFORMATION

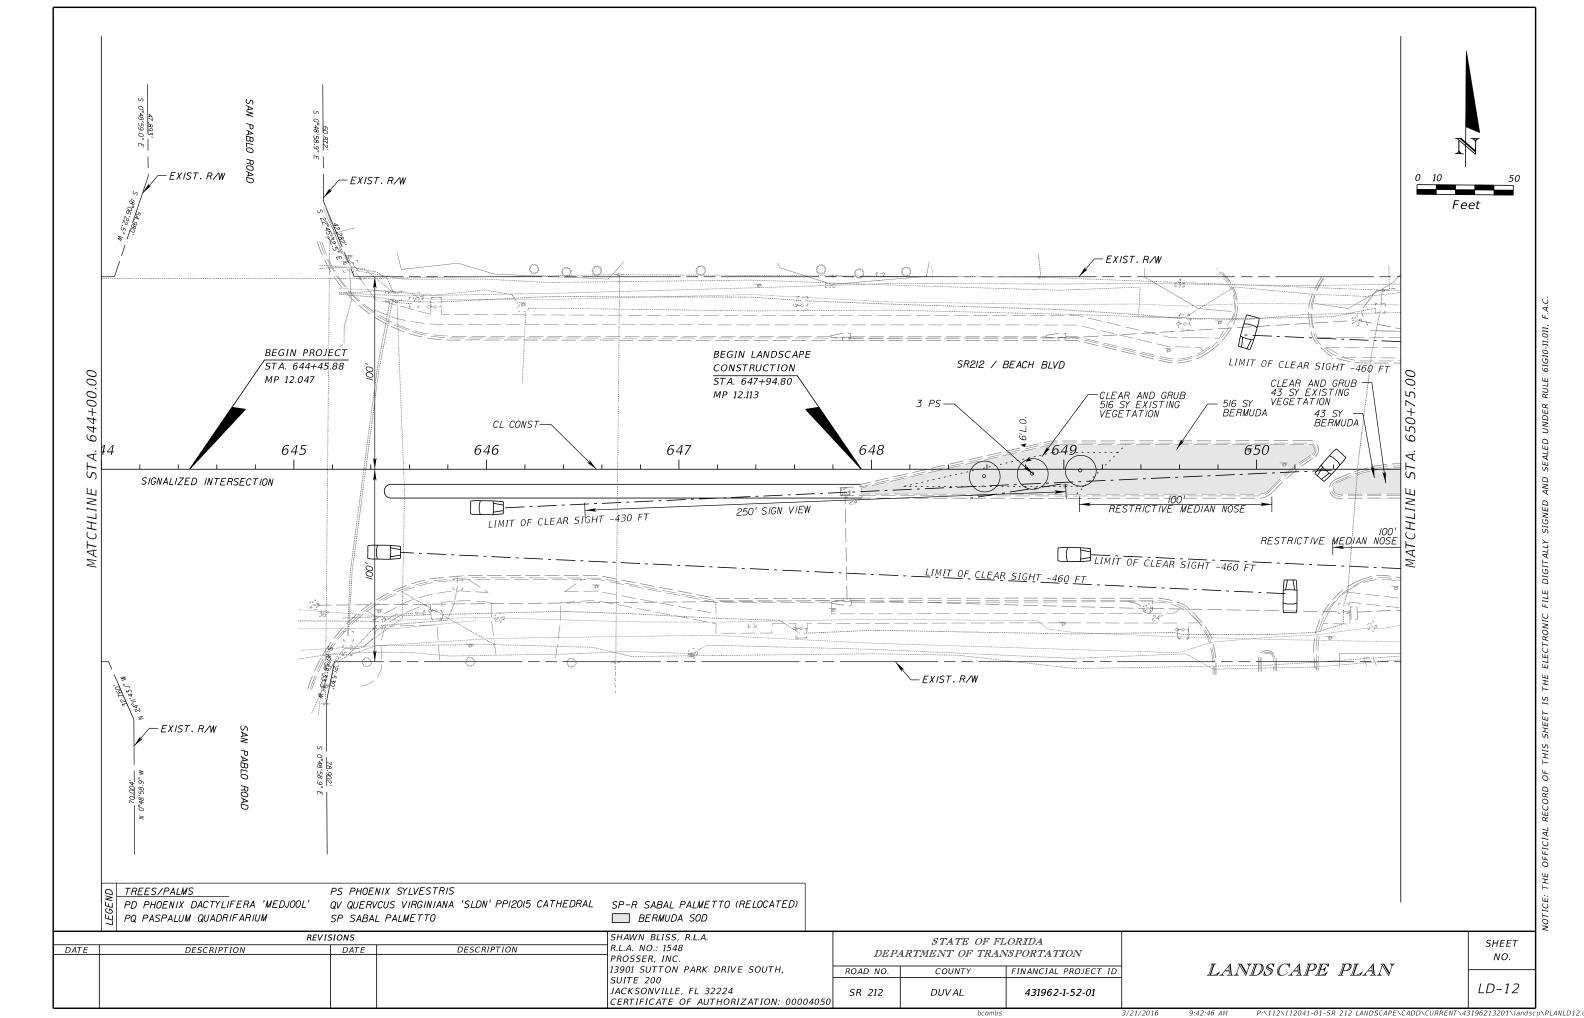
CLEAR CHANNEL MR. STEWART HOWE CLEAR CHANNEL OUTDOOR - JAX 11700 CENTRAL PARKWAY, SUITE 100 JACKSONVILLE, FL 32224 904-996-0442 OFFICE

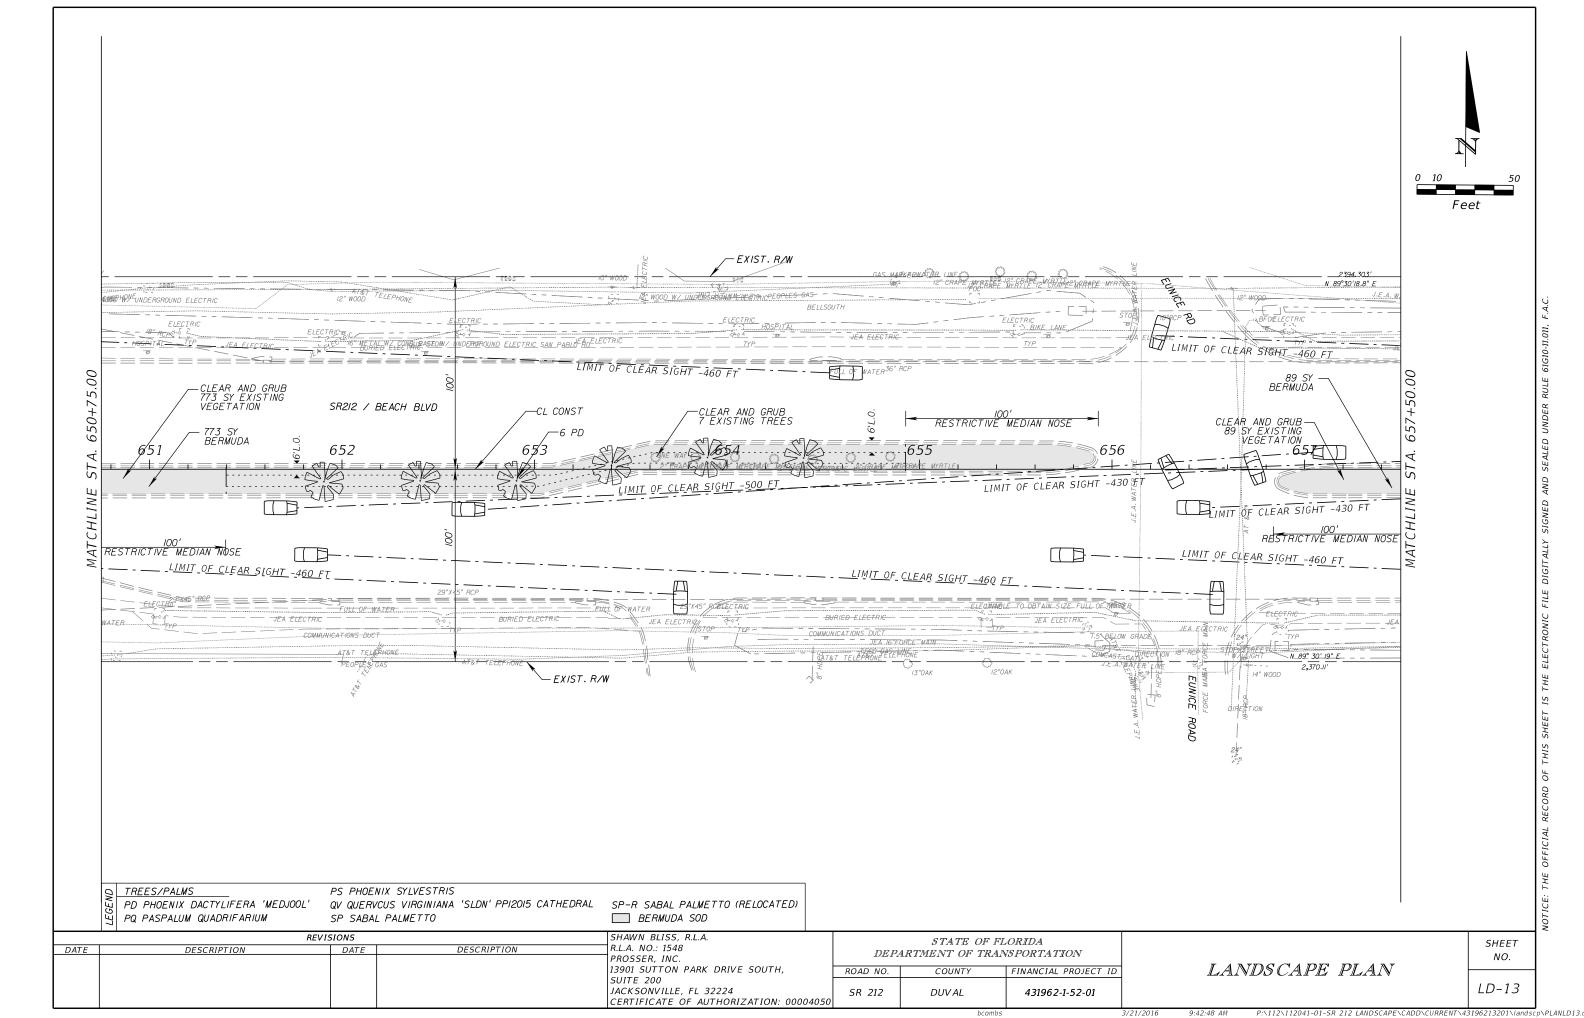
EMAIL: STEWARTHOWE@CLEARCHANNEL.COM

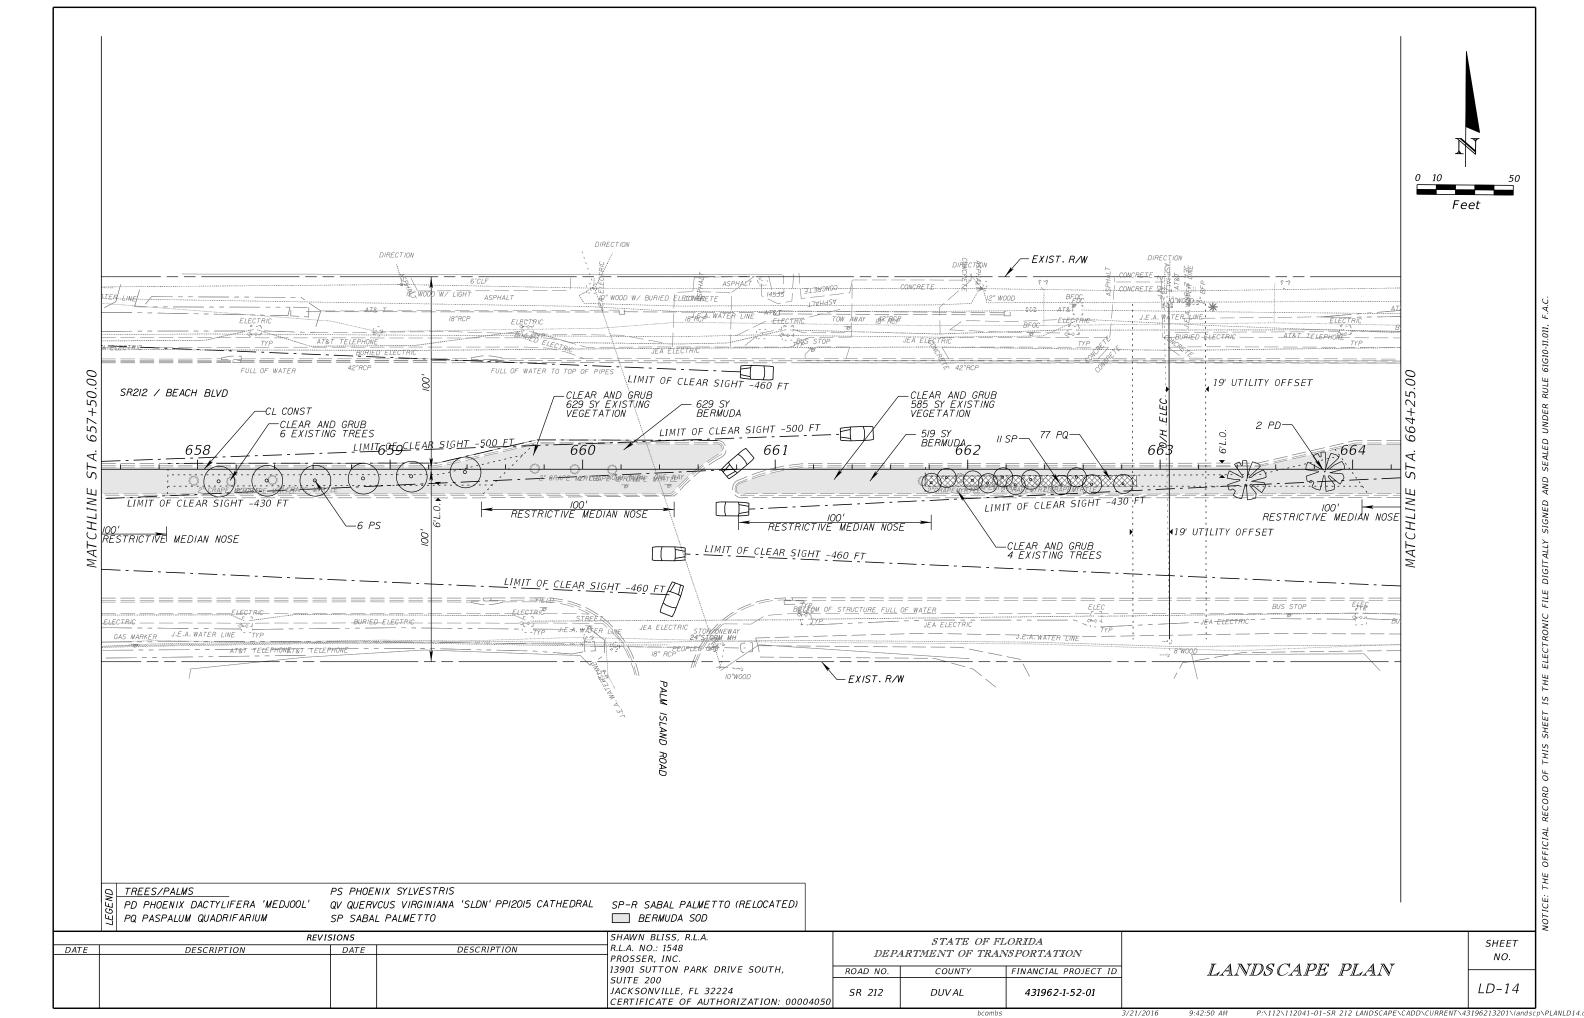
	RE	VISIONS		SHAWN BLISS, R.L.A.	STATE OF FLORIDA			
DATE	DESCRIPTION	DATE	DESCRIPTION	R.L.A. NO.: 1548	DEP.	DEPARTMENT OF TRAN	ANSPORTATION	
				PROSSER, INC.				
				13901 SUTTON PARK DRIVE SOUTH, SUITE 200	ROAD NO.	COUNTY	FINANCIAL PROJECT ID	
				JACKSONVILLE, FL 32224	SR 212	DUVAL	431962-1-52-01	
				CERTIFICATE OF AUTHORIZATION: 00004050		BOVALE	751502 1 52 01	

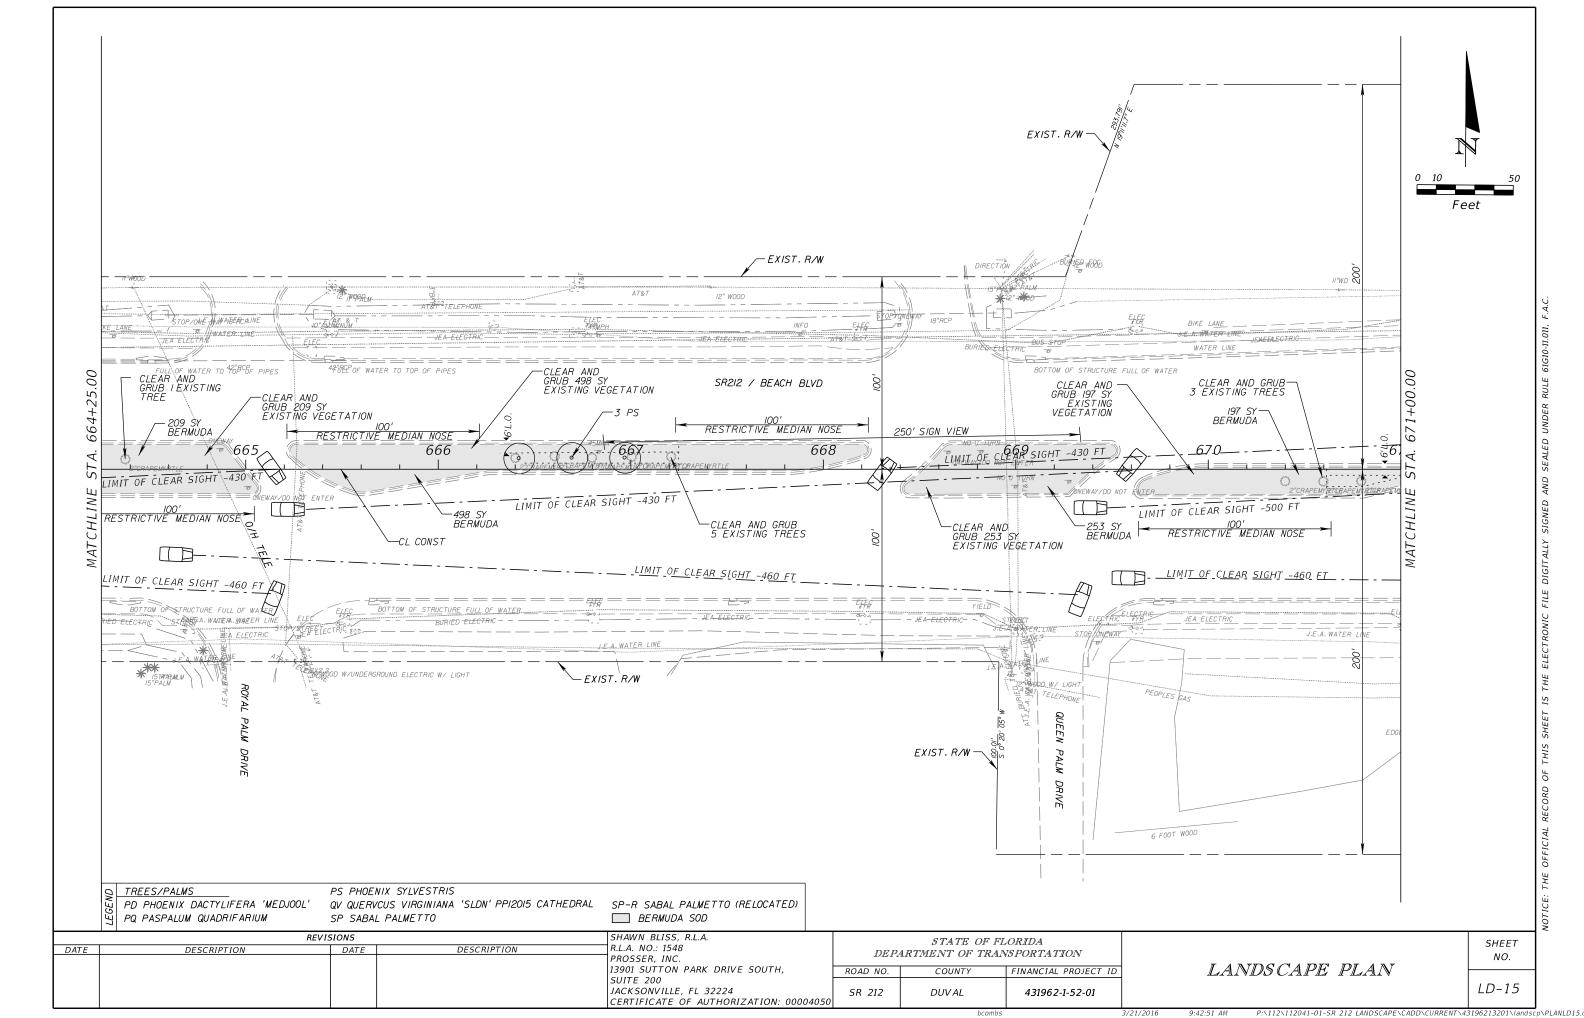
PROJECT NOTES

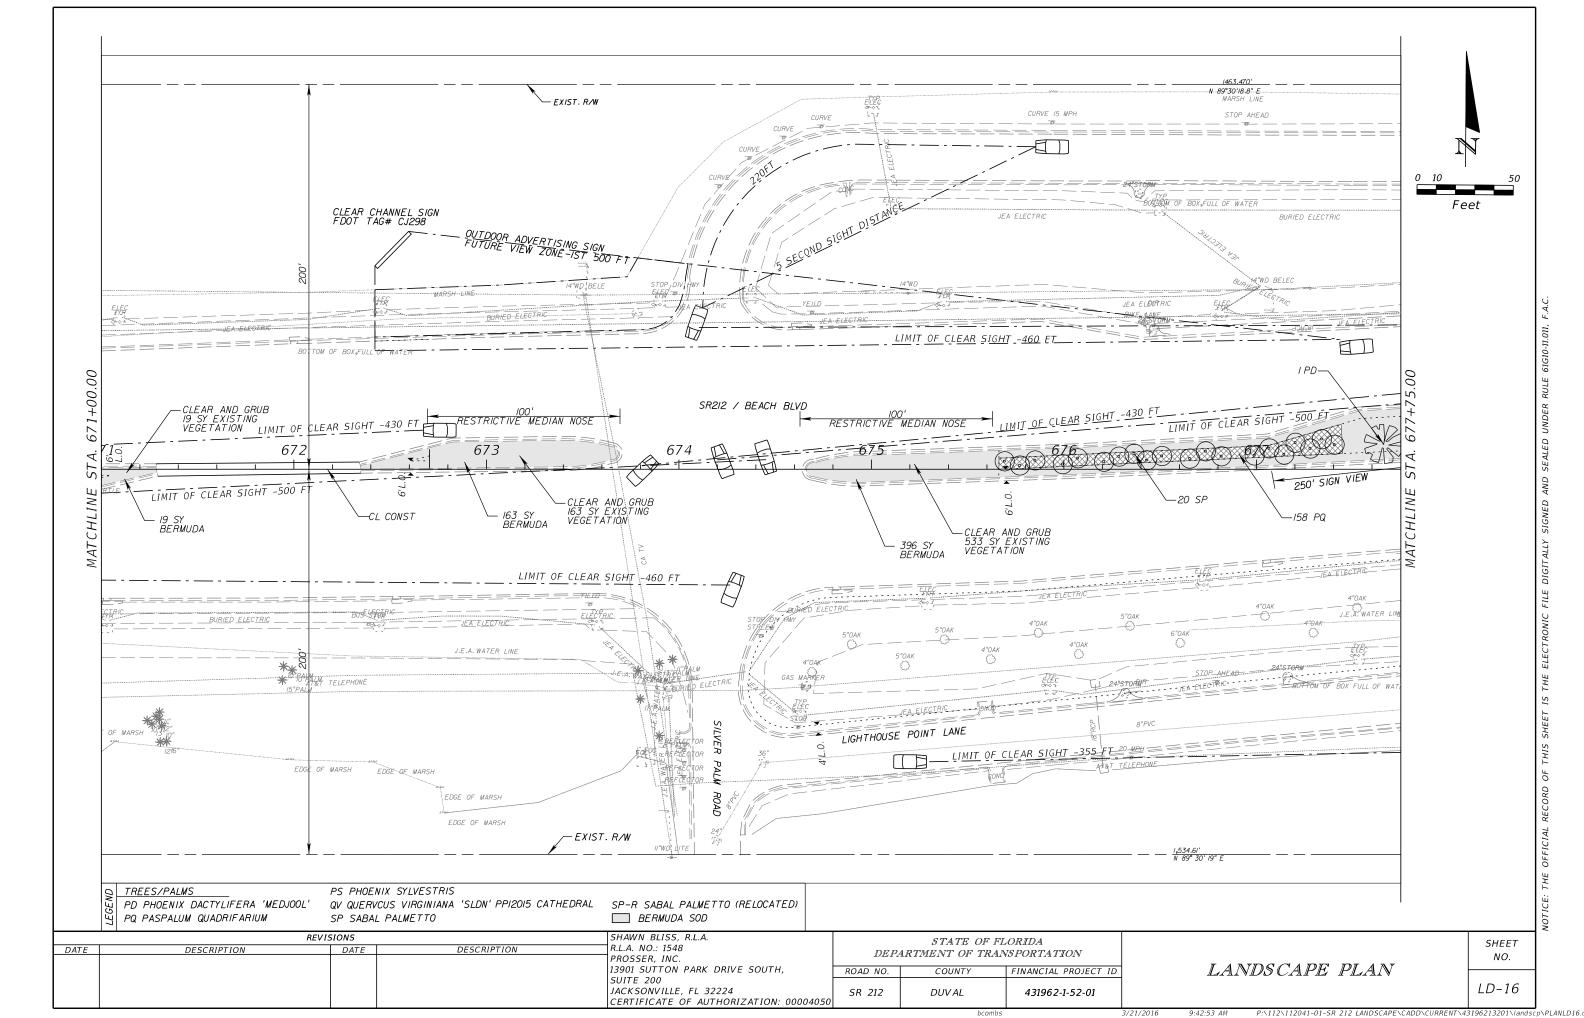
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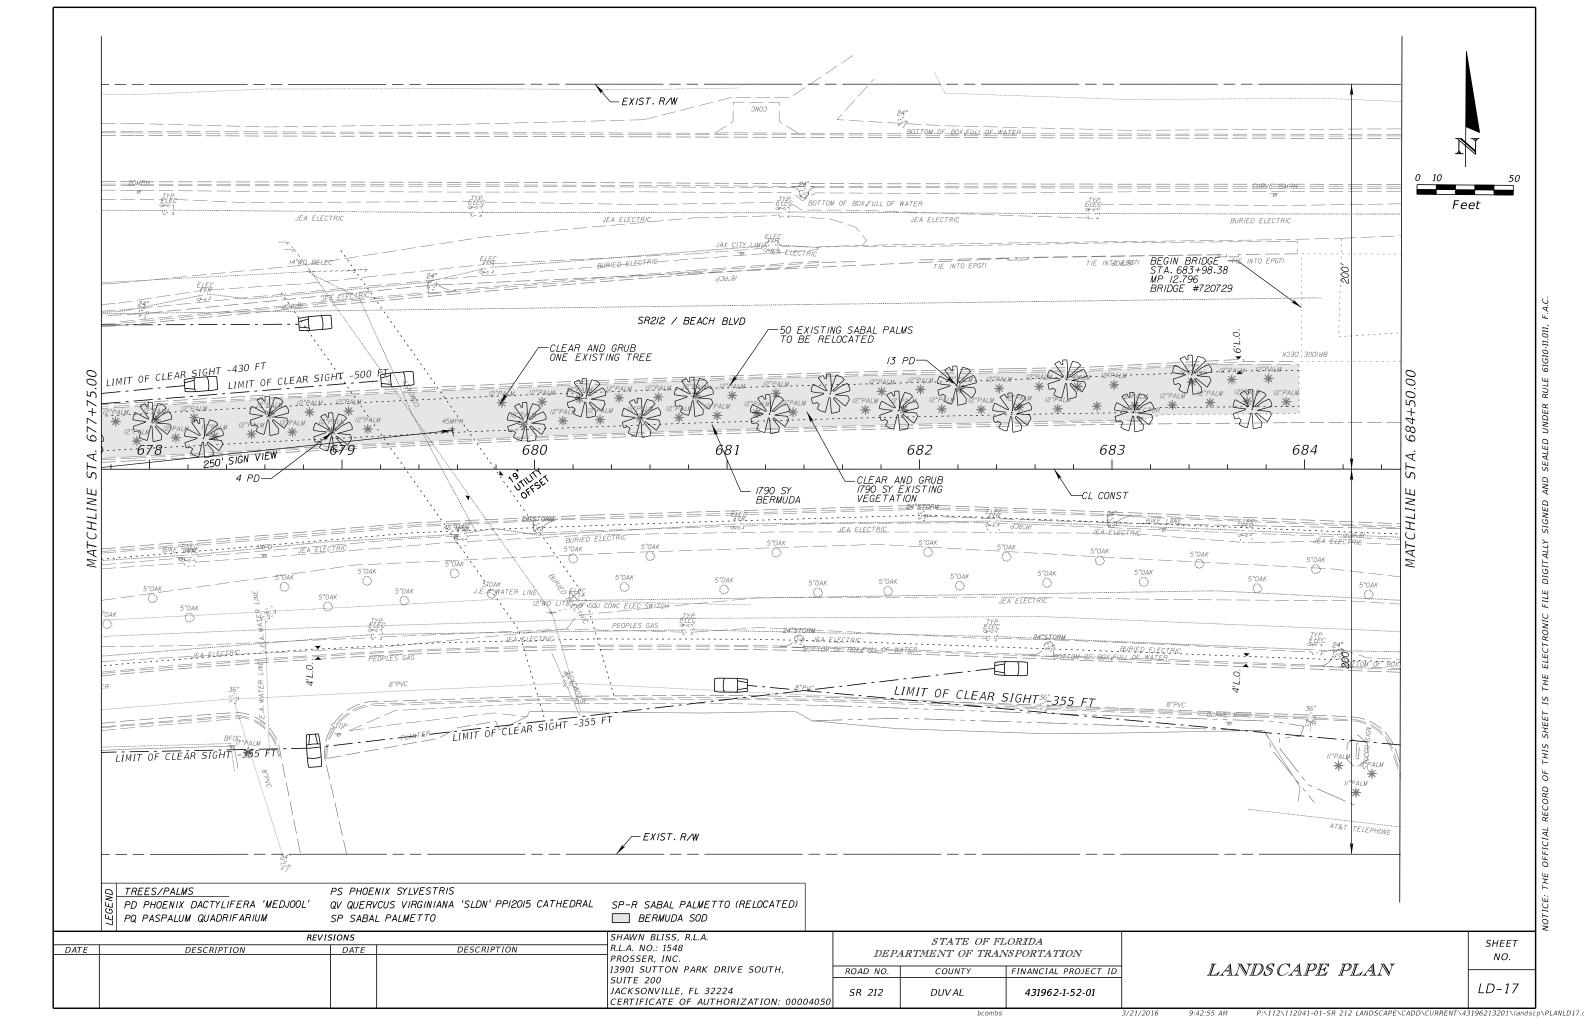


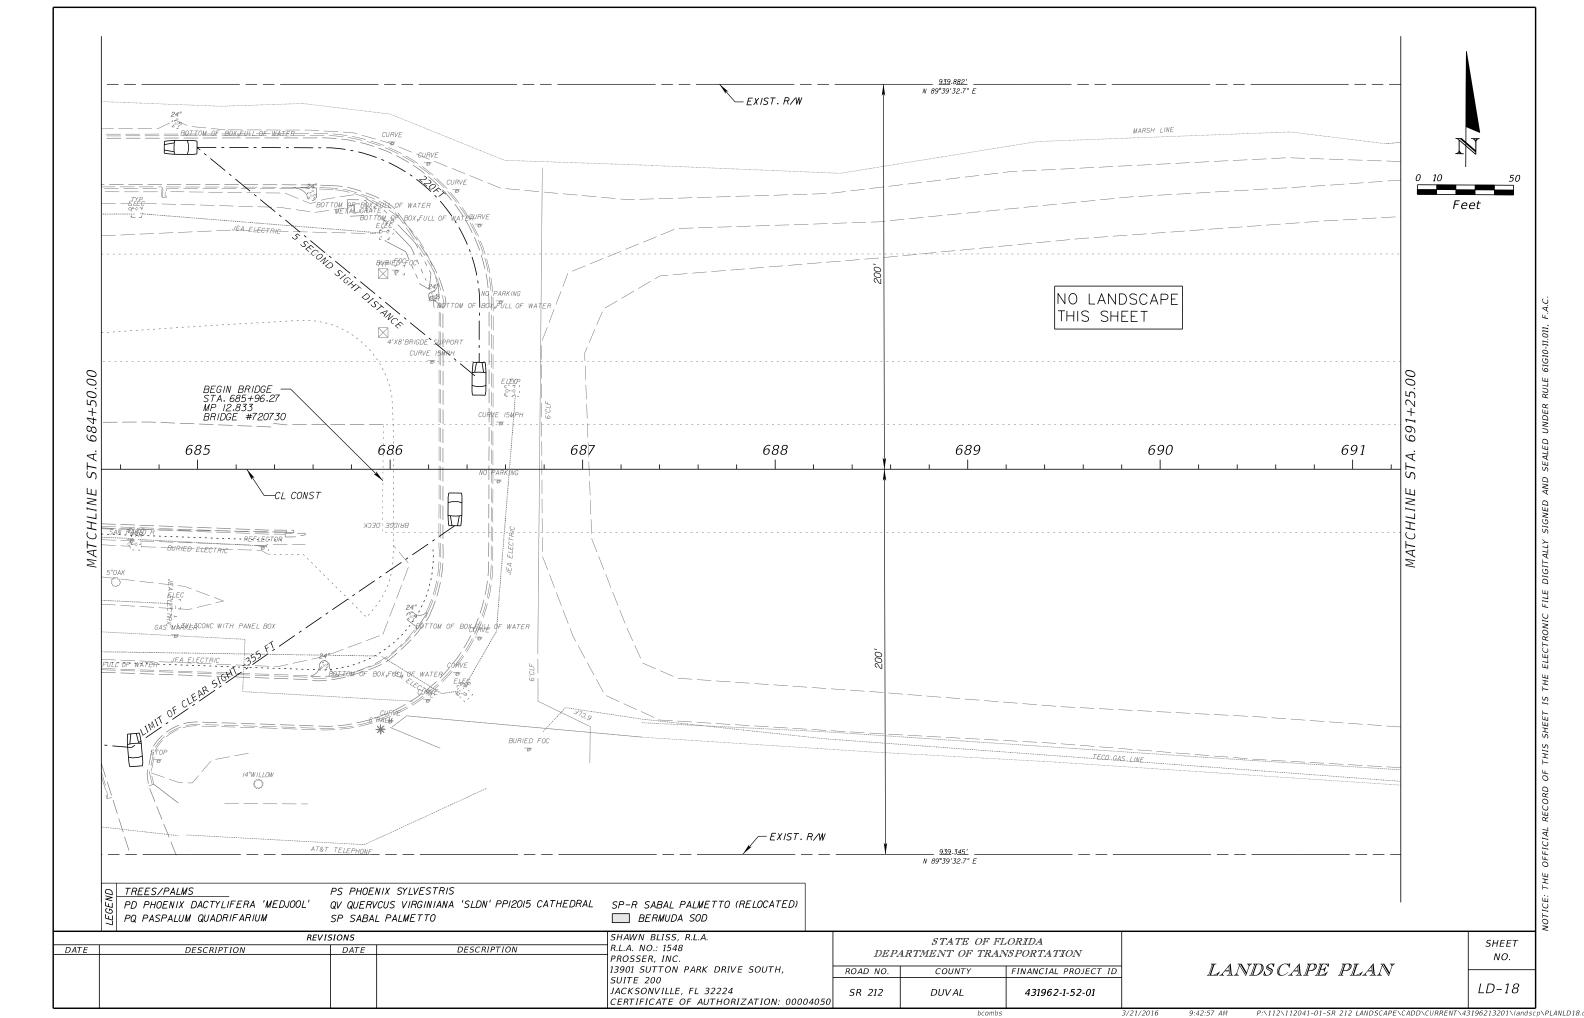


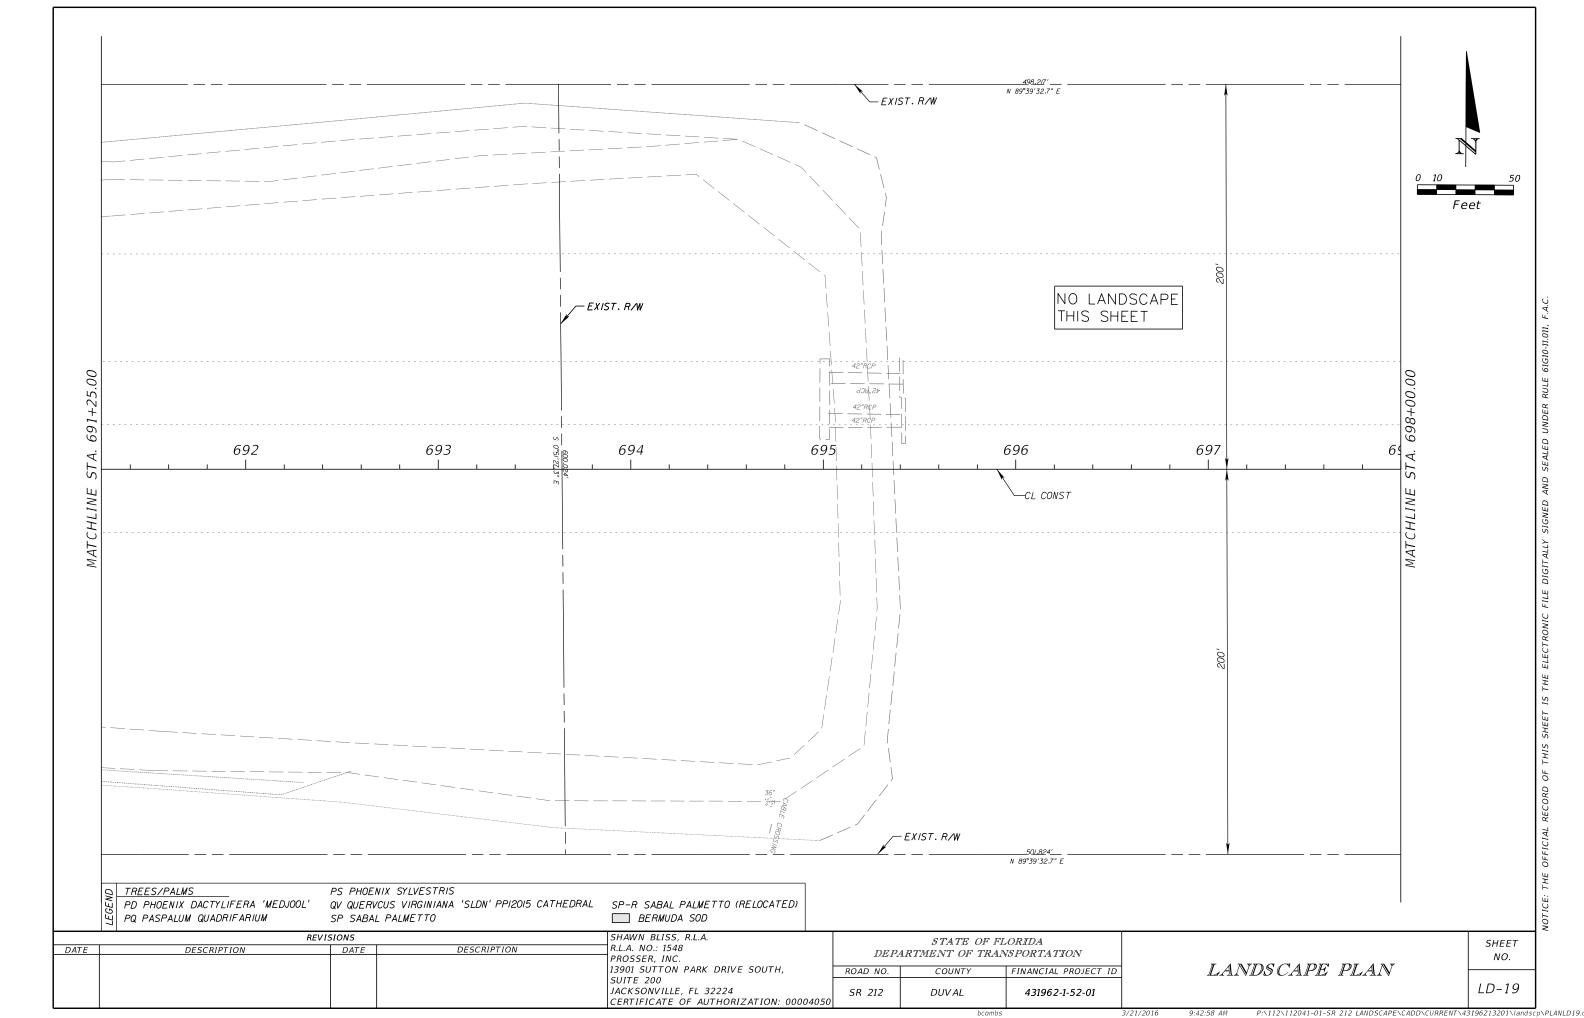


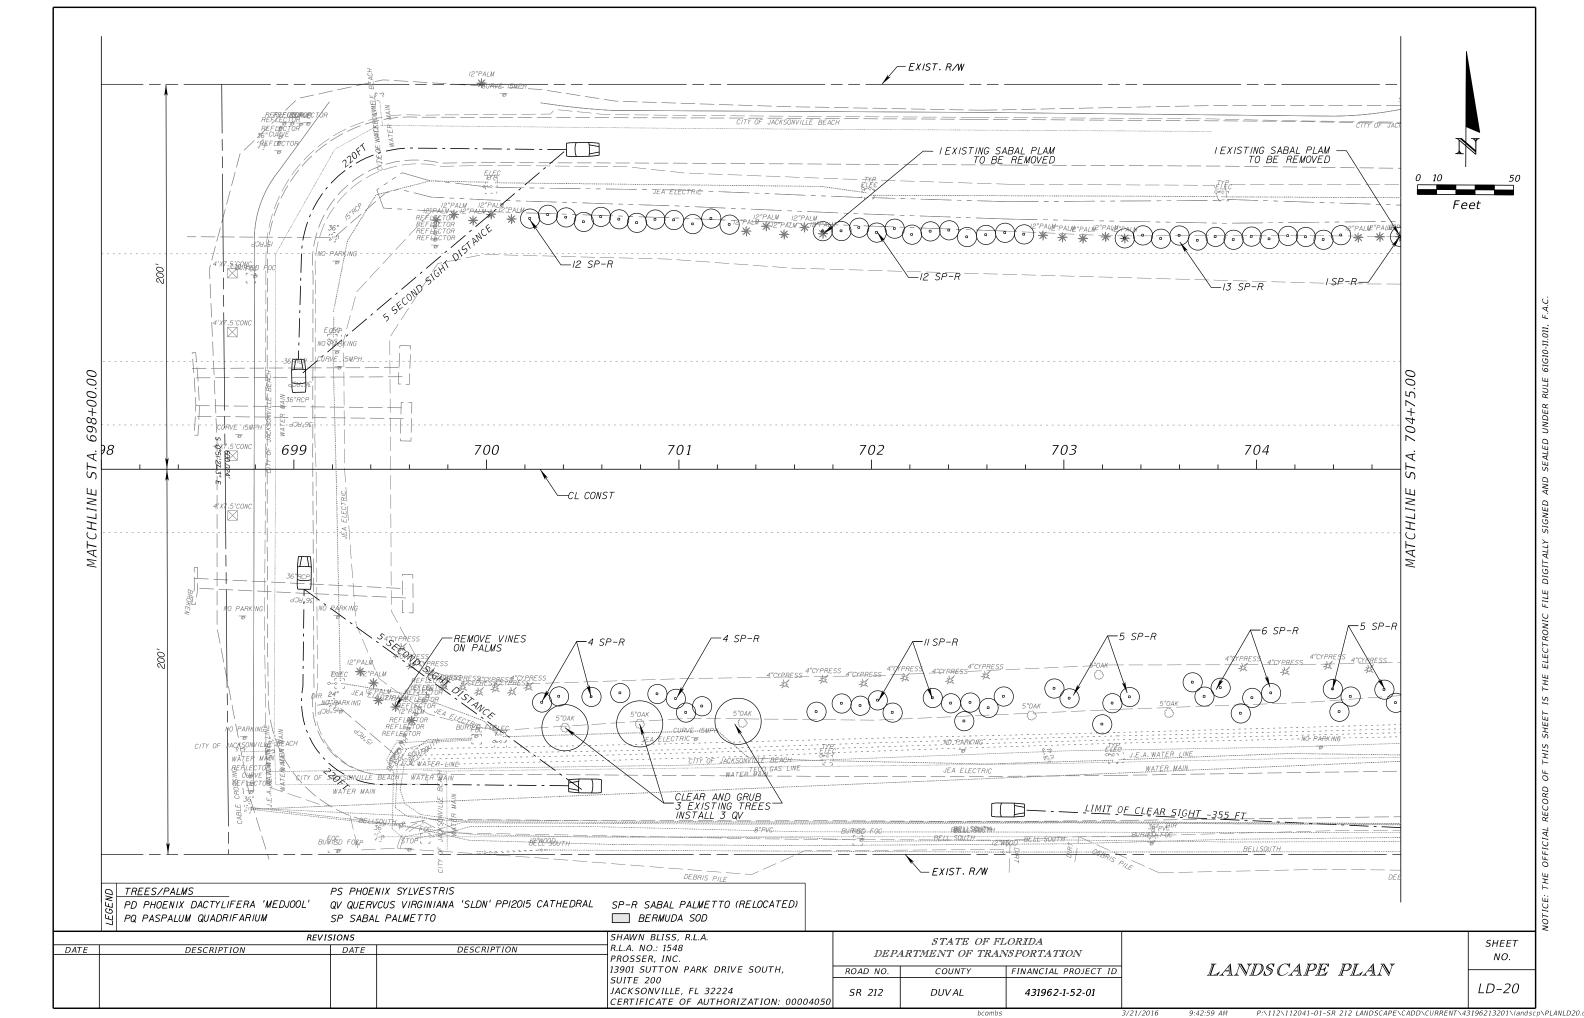


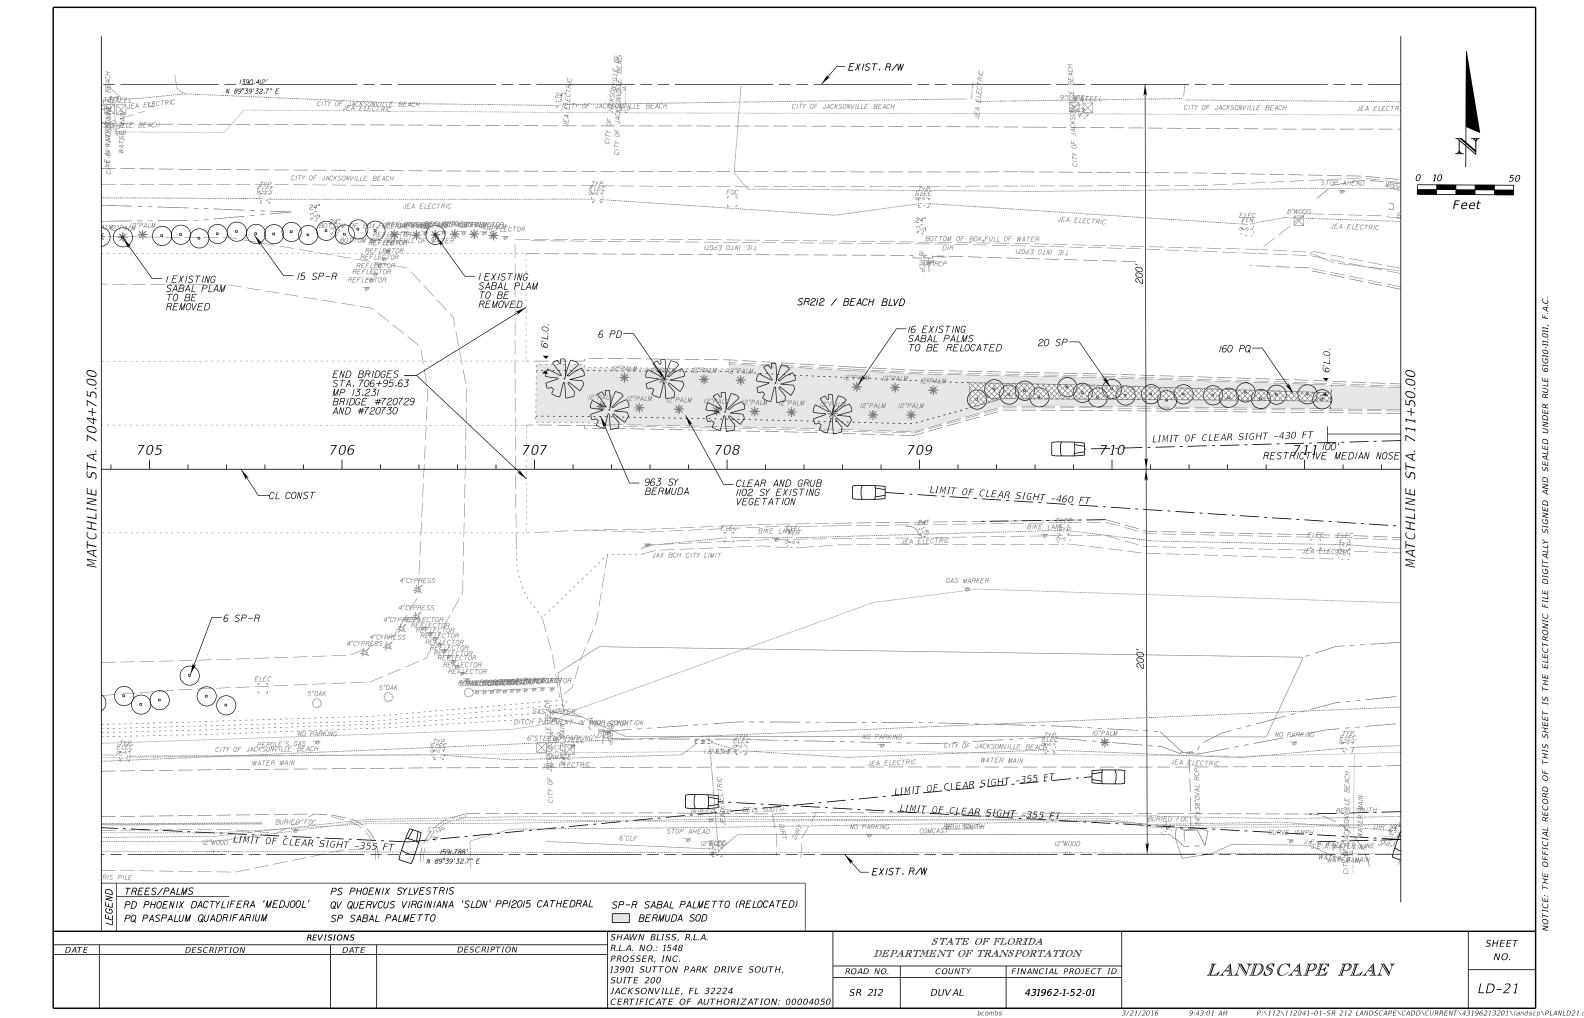


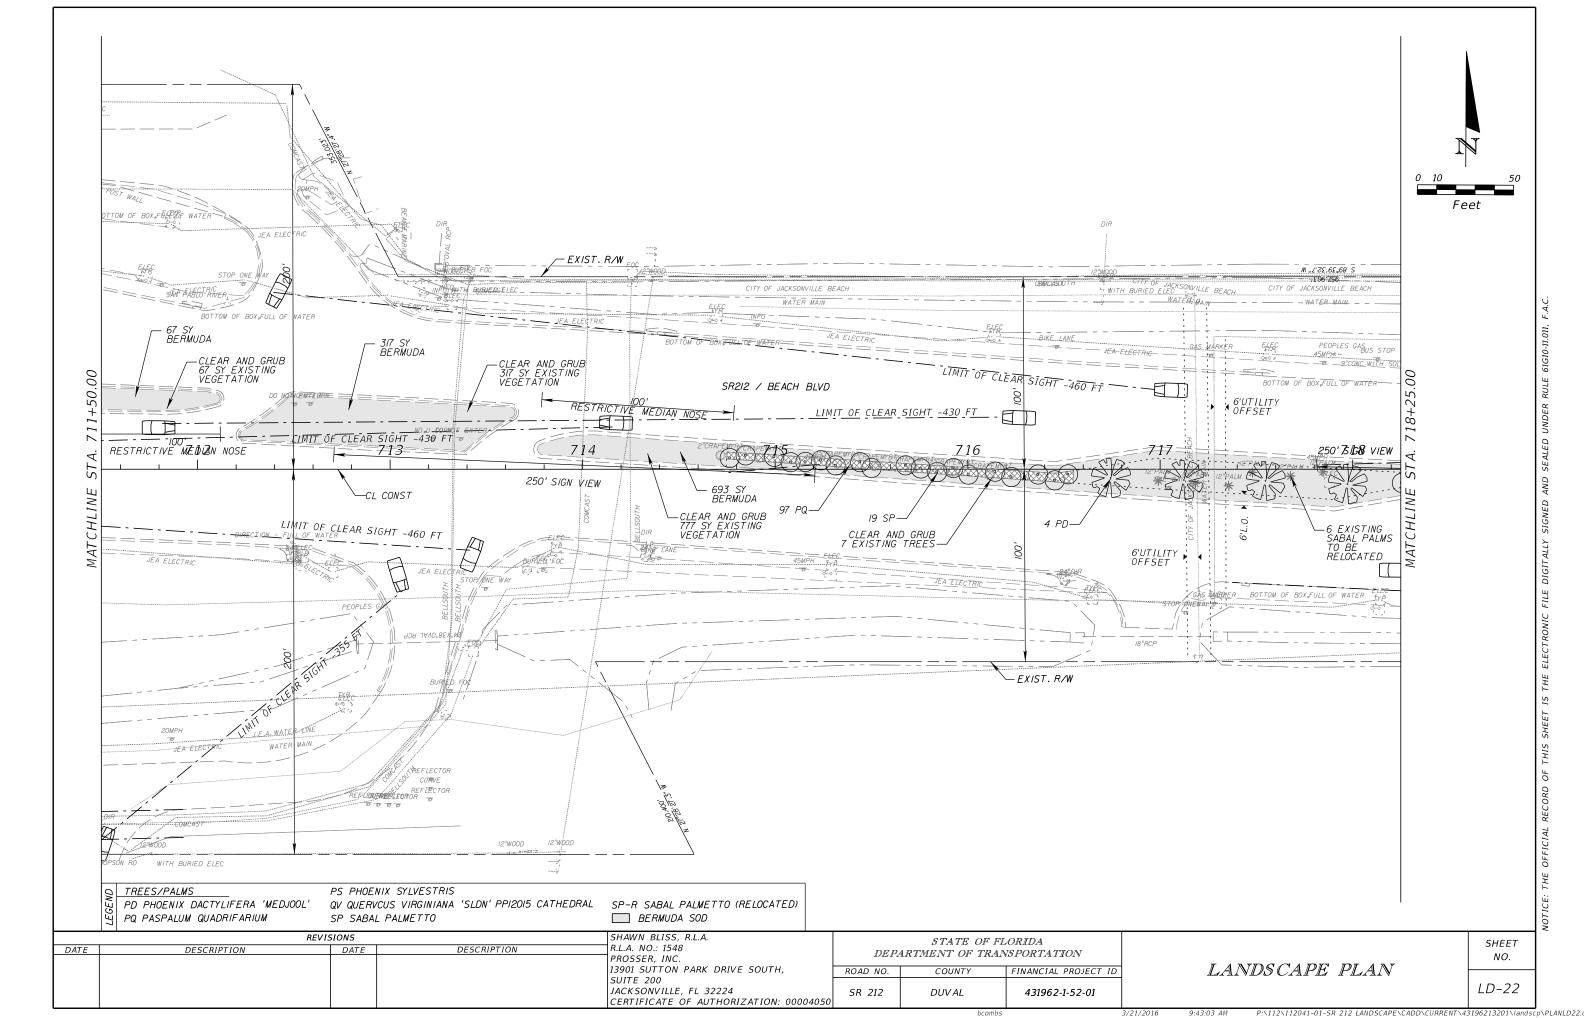


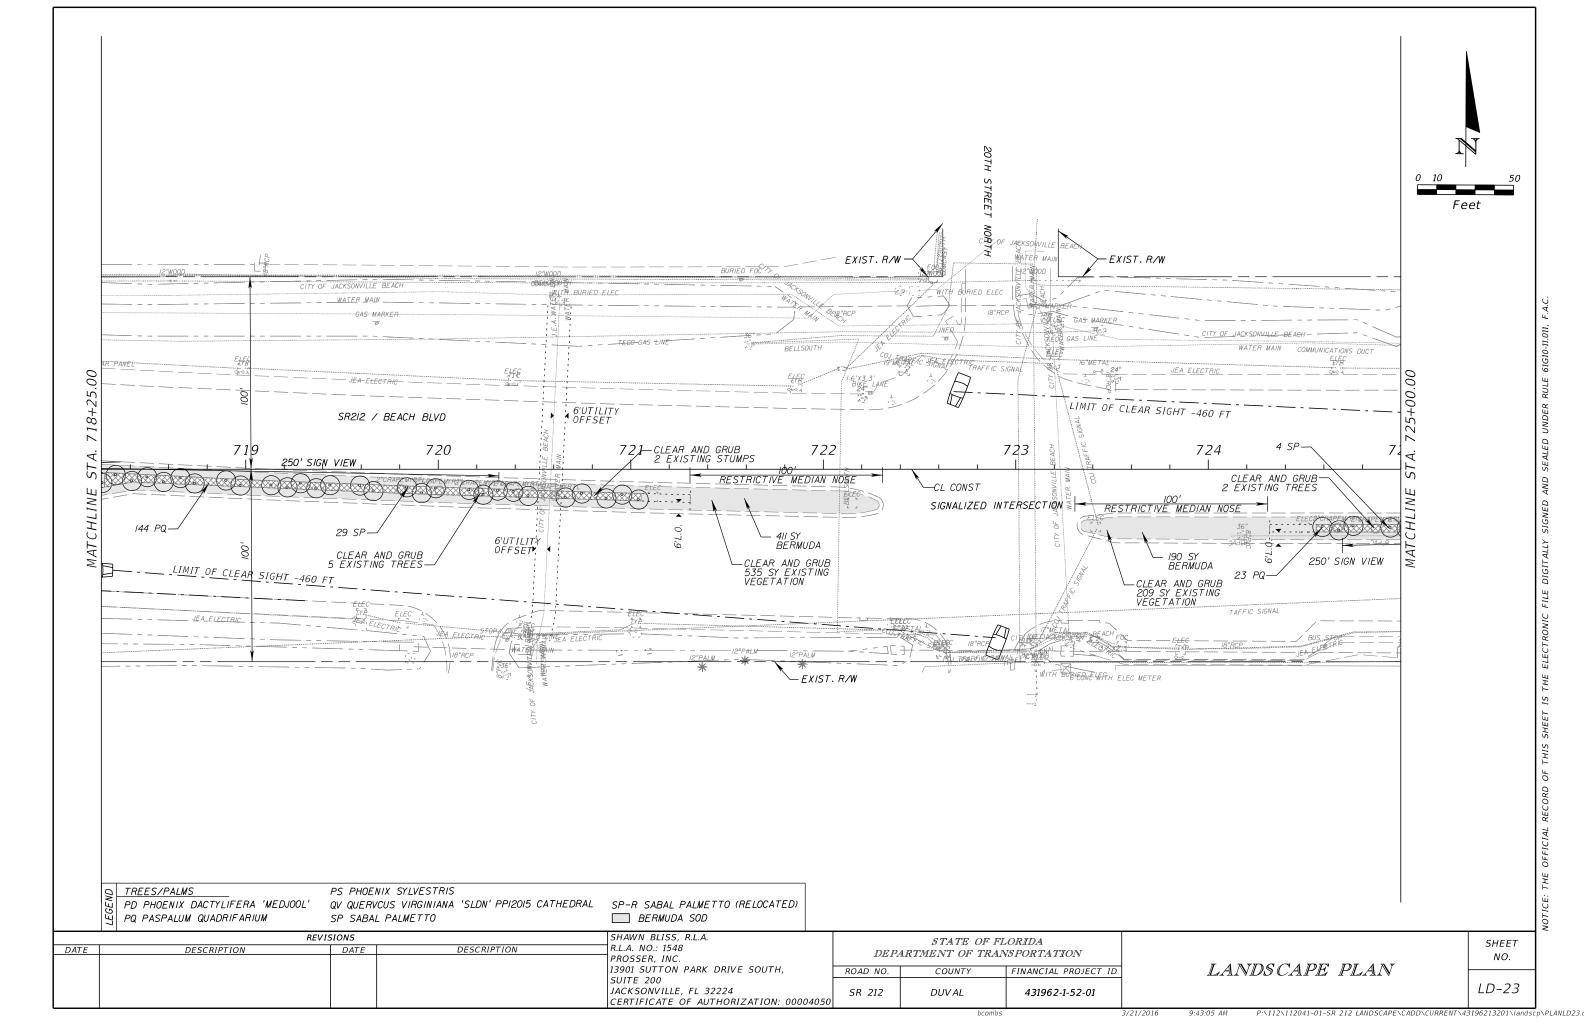


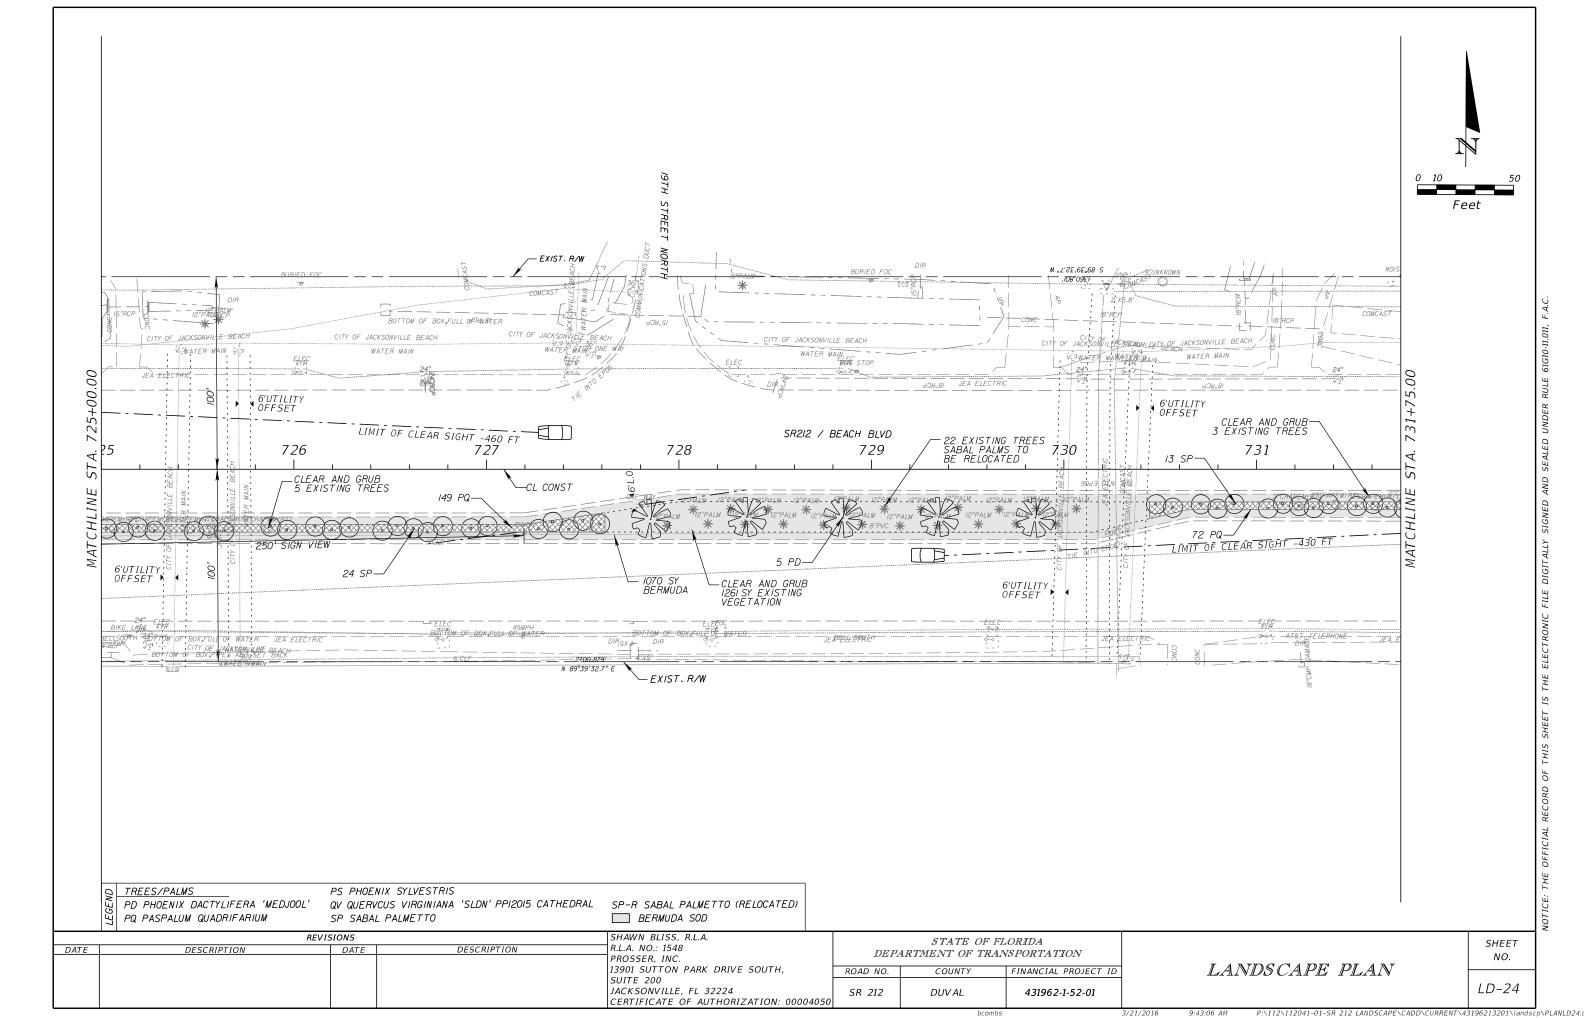


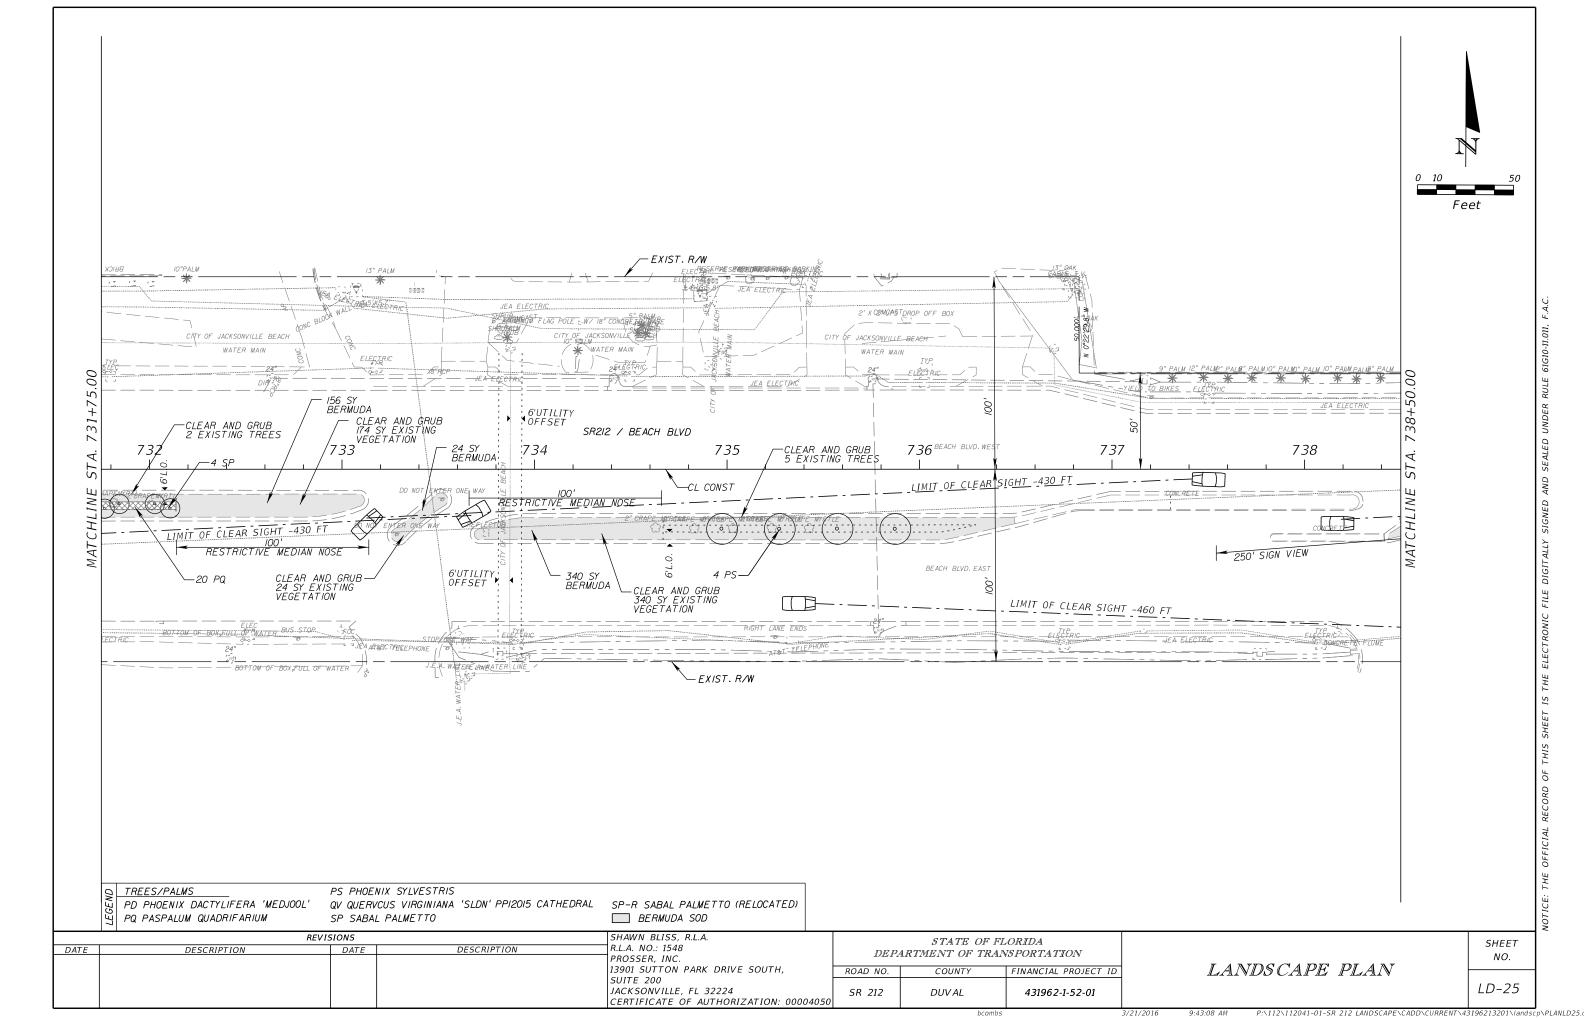


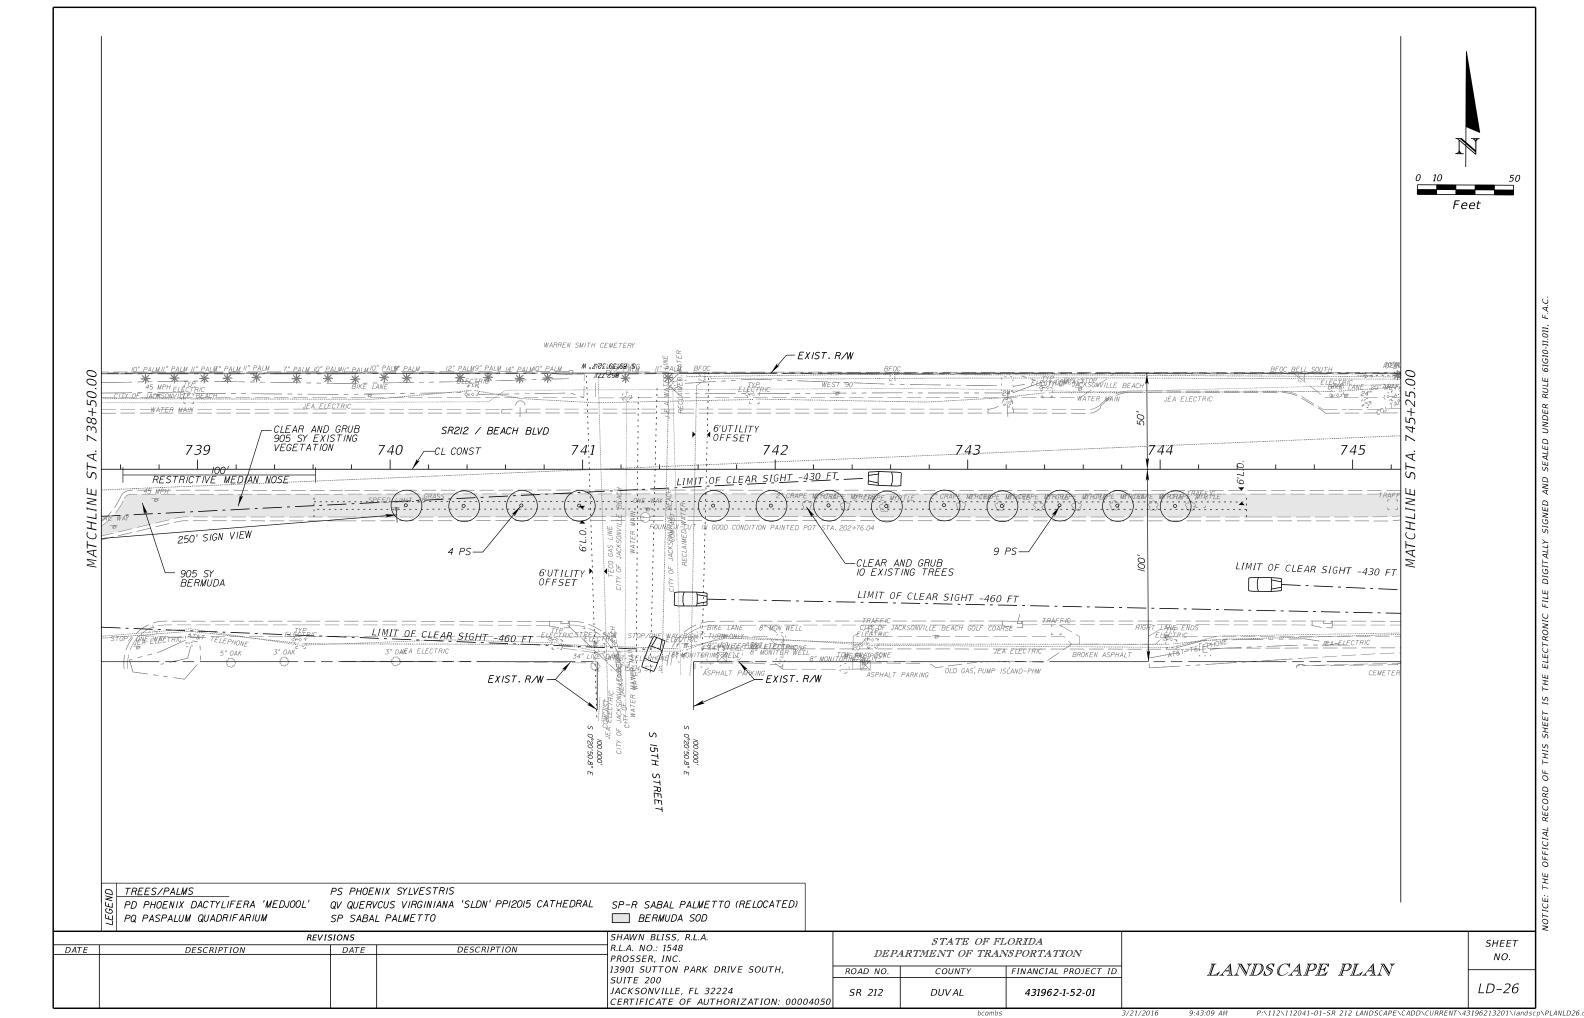


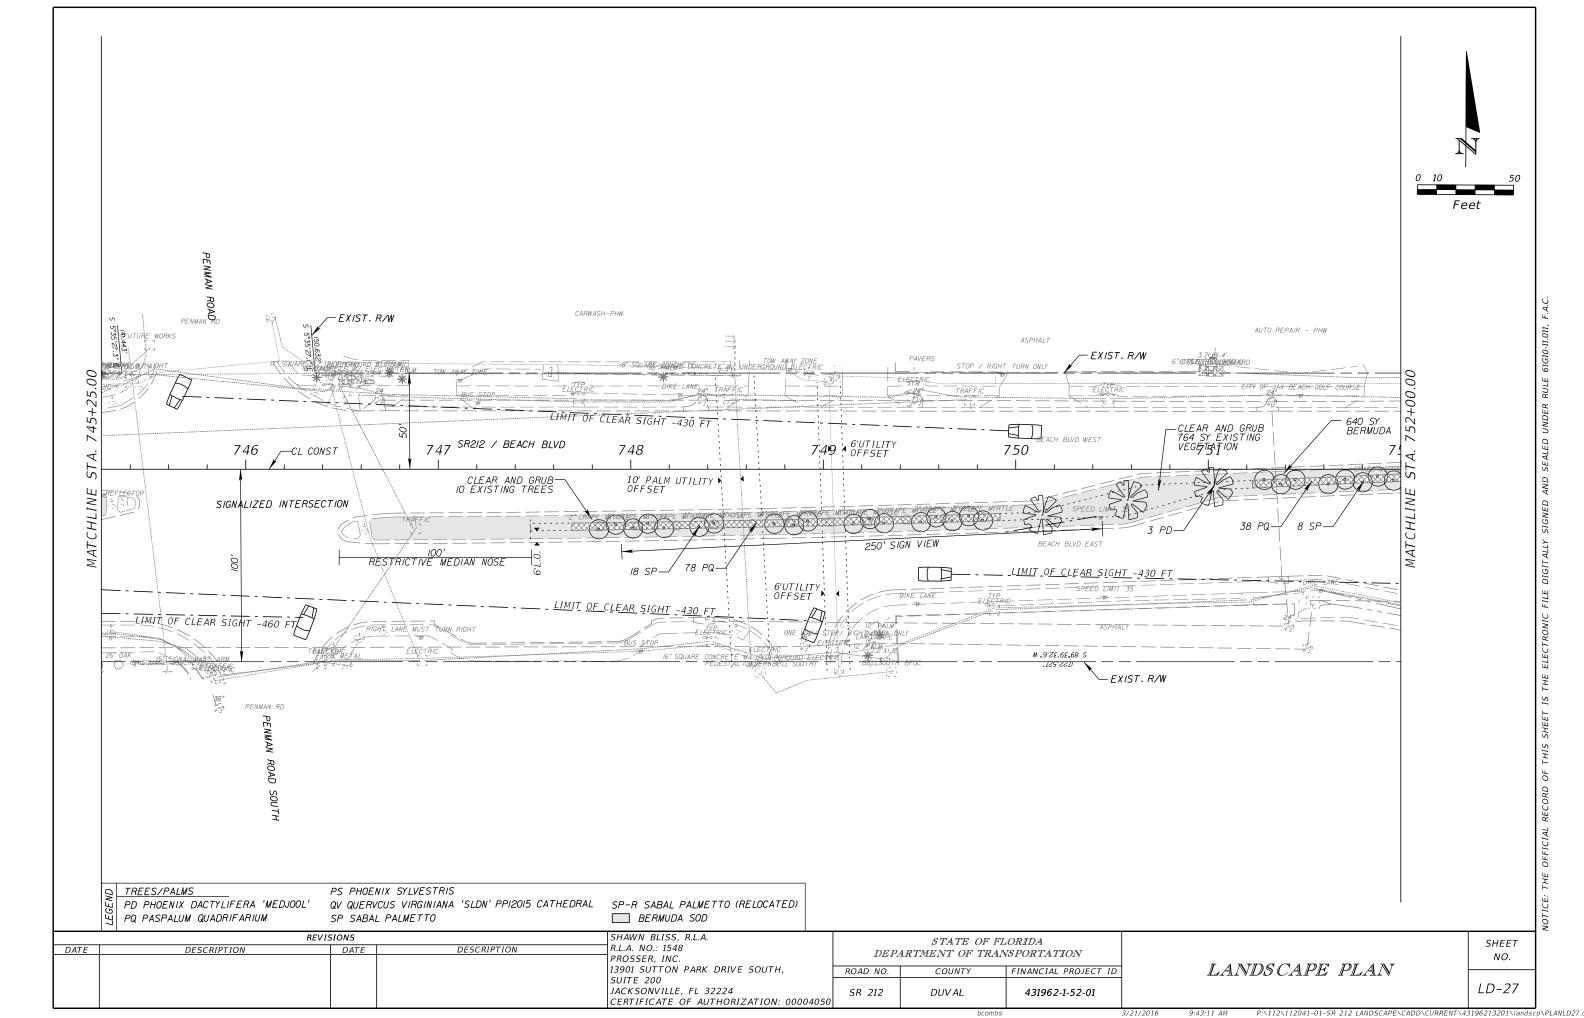


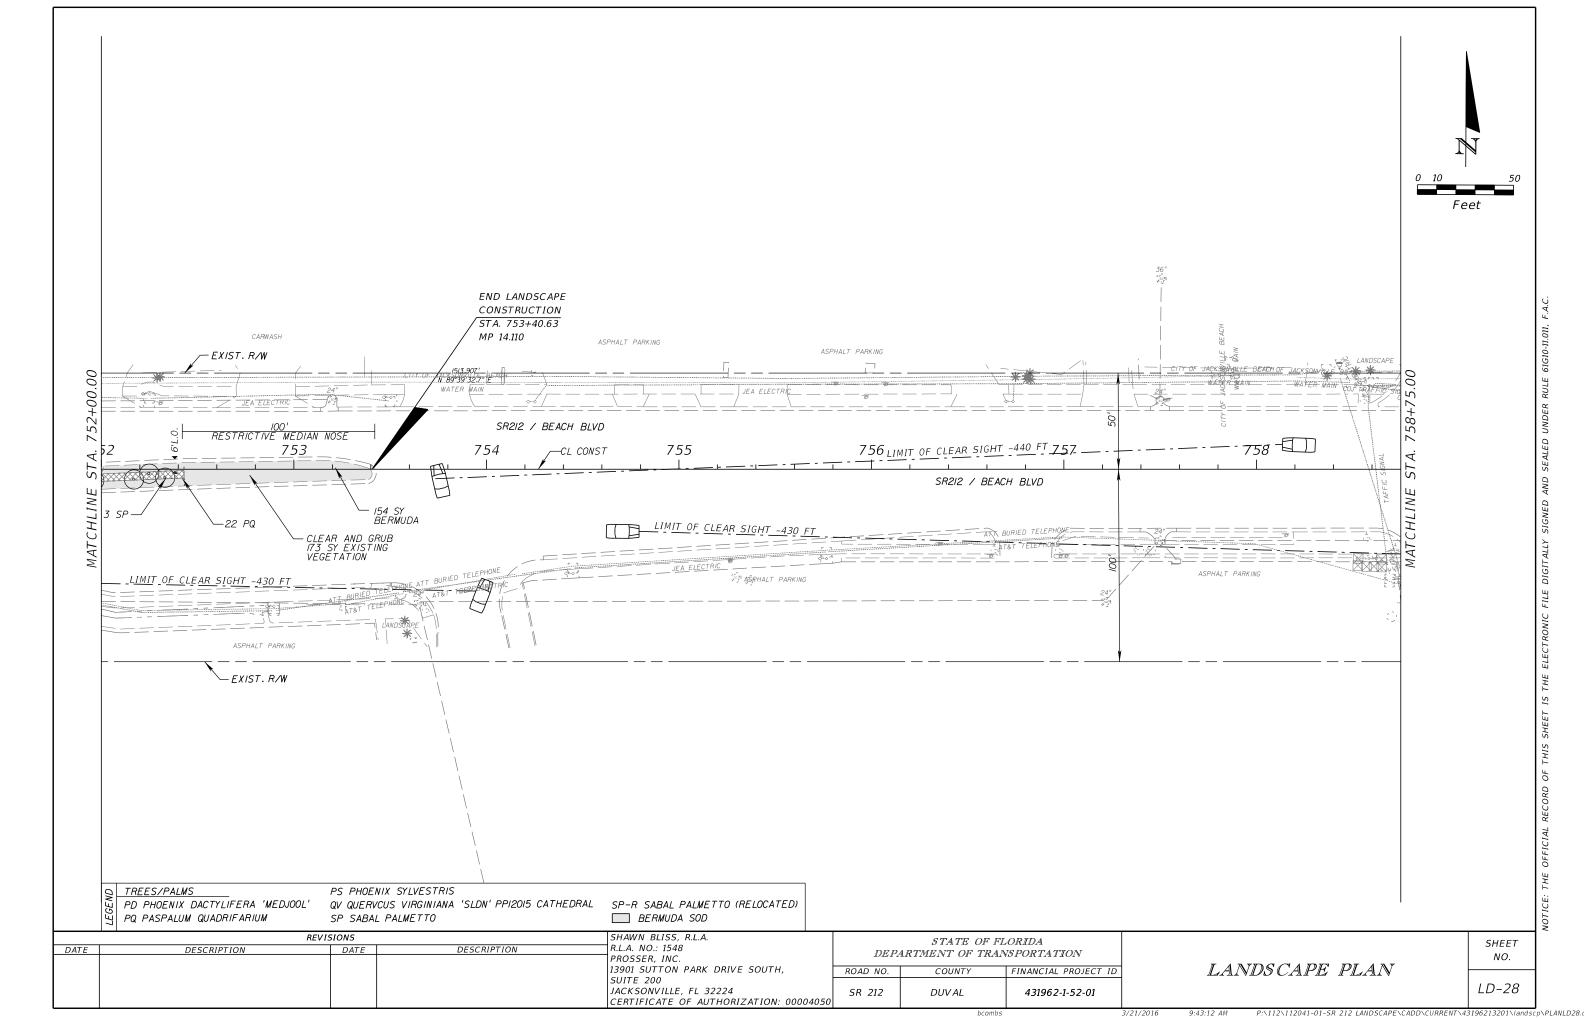


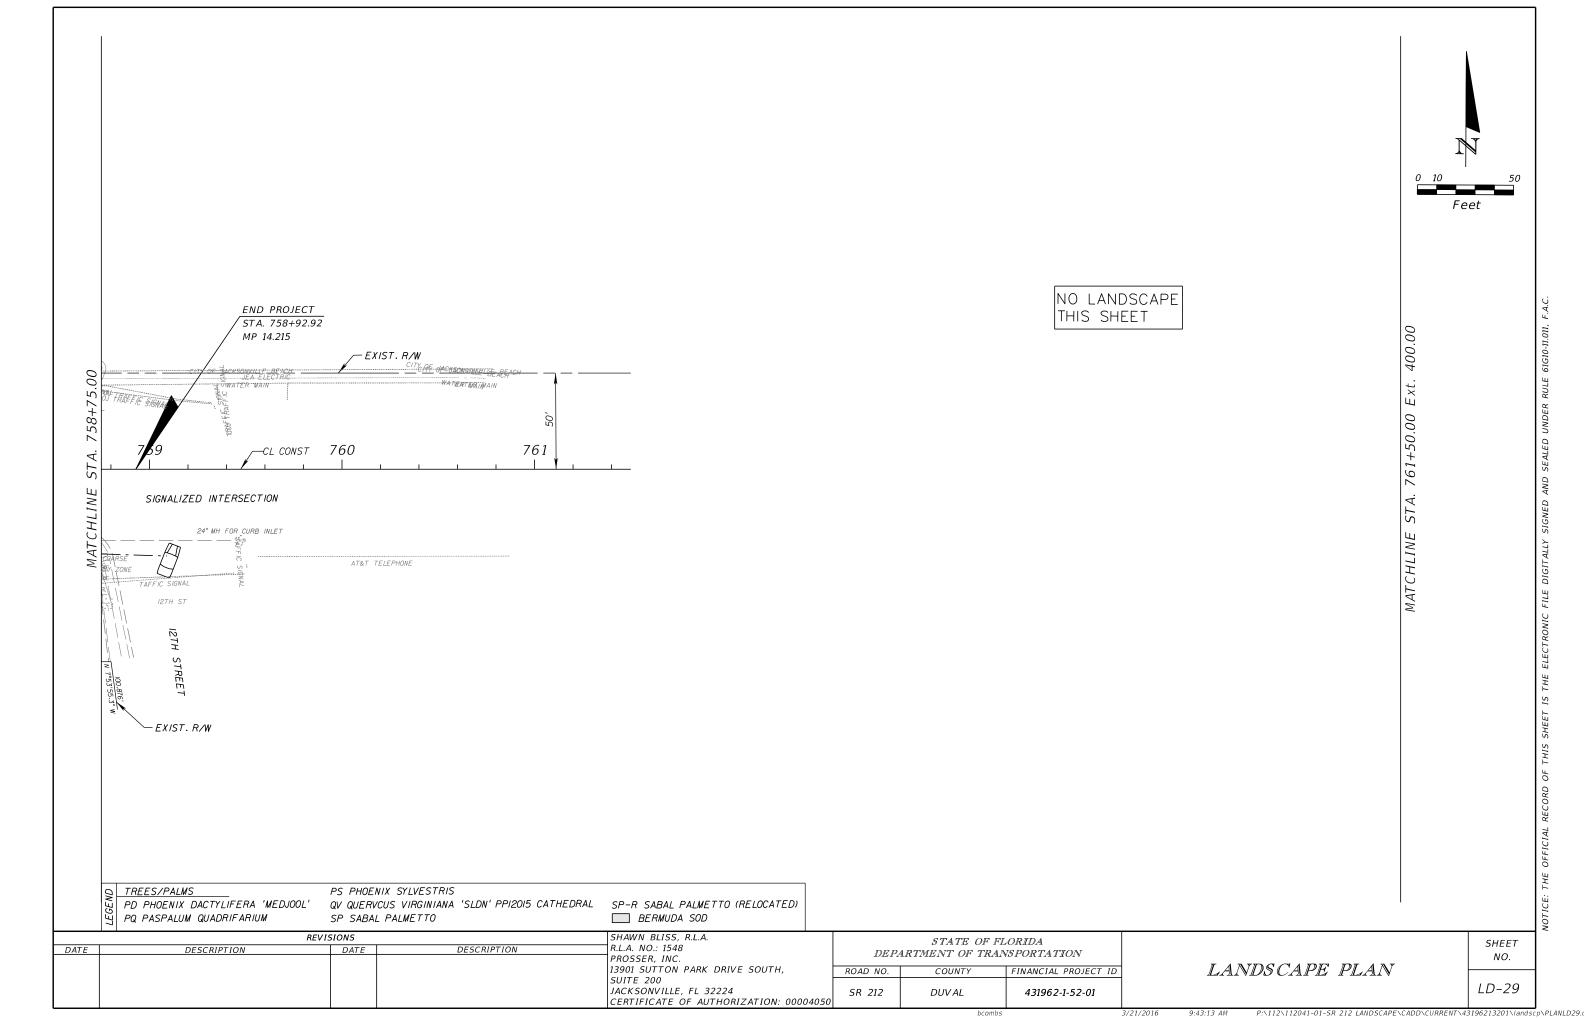












IRRIGATION SCHEDULE POTABLE WATER METER

SYMBOL	MANUFACTURER/MODEL	QTY	<u>ARC</u>
×	Pressure Compensating Flood Bubbler	31	360
	Two Pressure Compensating Flood Bubbler	37	360
	Area to Receive Dripline On—Surface Pressure Compensating Landscape Dripline. 0.9GPH emitters at 12.0" O.C. Dripline laterals spaced at 18.0" apart, with emitters offset for triangular pattern. UV Resistant.	1,500	
lacktriangle	Remote Control Valve 1" in 12" Valve Box	2	
	Remote Control Valve 1" in 12" Valve Box and Pressure Regulator 40 psi and Filter 1" in 12" Valve Box	1	
E	Battery Operated Irrigation Controller 4 Stations	1	
(S)	Rain and Freeze Sensor located in an exposed location to detect moisture	1	
M	Potable Water Meter 1"	1	
BF	Reduced Principal Backflow Device 1"	1	
	Irrigation Lateral Line: PVC Class 200 Solvent Weld	5,000	
	Irrigation Mainline: PVC 2" Class 200 Solvent Weld	120	
(SIZE) DIRECTIONAL BORE	Directional Bore: 30" deep HDPE 3608 IPS Directional Bores sized per plan. Directional bores to have fused HDPE by schedule 40 male threaded ends and be used as mainline or lateral as shown.		

	Valve Callout
	Valve Number
<u> </u>	Valve Flow
#" •	——— Valve Size

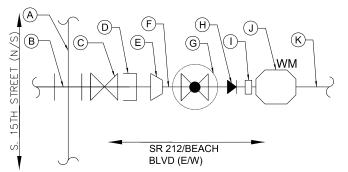
IRRIGATION NOTES:

1. IRRIGATION PIPING AND EQUIPMENT SHOWN WITHIN ROAD IS FOR GRAPHIC CLARITY, INSTALL IRRIGATION WITHIN ADJACENT LANDSCAPE AREAS.

IRRIGATION SCHEDULE RECLAIMED WATER METER

	S S S S S S S S S S S S S S S S S S S					
SYMBOL	MANUFACTURER/MODEL	QTY	<u>ARC</u>	<u>PSI</u>	GPM R	RADIUS
H	Pressure Compensating Flood Bubbler	238	360	30	0.25	1'
	Two Pressure Compensating Flood Bubbler	38	360	30	2x.25	1'
	Area to Receive Dripline On—Surface Pressure Compensating Landscape Dripline. 0.9GPH emitters at 12.0" O.C. Dripline laterals spaced at 18.0" apart, with emitters offset for triangular pattern. UV Resistant.	5,300				
lacktriangle	Remote Control Valve 1" in 12" Purple Valve Box	6				
	Remote Control Valve 1" in 12" Purple Valve Box and Pressure Regulator 40 psi and Filter 1" in 12" Purple Valve Box	4				
ABCD	Battery Operated Irrigation Controller 4 Stations	4				
<u>S</u> >	Rain and Freeze Sensor located in an exposed location to detect moisture	4				
R	Reclaimed Water Meter 1"	1				
S	Reclaimed Water Advisory Sign	8				
X	Isolation Valve 2" in 12" Purple Valve Box	4				
	Irrigation Lateral Line: PVC Class 200 Purple Solvent Weld	8,500)			
	Irrigation Mainline: PVC 2" Class 200 Purple Solvent Weld	3,300)			
(SIZE) DIRECTIONAL BORE	Directional Bore: 30" deep HDPE 3608 IPS Directional Bores sized per plan. Directional bores to have fused HDPE by schedule 40 male threaded ends and be used as mainline or lateral as shown.					
EXISTING 8" SLEEVE	Pipe Sleeve: Existing 8" PVC Schedule 40 Work shall include removal and clearing of debris from existing sleeves as required.					

RE-USE WATER CONNECTION



GPM RADIUS

0.25 1' 2x.25 1'

LEGEND:

- A EXISTING 12" REUSE PIPE TO REMAIN
- B EXISTING 12" X 6" CROSS TO REMAIN
- C EXISTING 6" VALVE TO REMAIN
- D REMOVE EXISTING 6" PLUG AND INSTALL NEW 6" PLUG (RESTRAINED) TAPPED 2"
- E INSTALL CORPORATION STOP
- F INSTALL 2" POLYETHYLENE TUBING
- G INSTALL 2" CURB STOP WITH VALVE BOX AND COVER (IDENTIFIED AS REUSE)
- H INSTALL 2" X 1" REDUCER BUSHING
- I INSTALL 1" METER COUPLING
- J INSTALL 1" WATER METER WITH BOX AND LID WITH "REUSE METER" LABEL
- K INSTALL IRRIGATION MAINLINE PER IRRIGATION PLANS

INSTALL REUSE SIGNS PER FDEP 62-10.468-469, SEE IRRIGATION PLANS FOR LOCATIONS

	F	REVISIONS		JANET O. WHITMILL, R.L.A.		STATE OF	FLORIDA	
DATE	DESCRIPTION	DATE	DESCRIPTION	R.L.A. NO.: 1289 JANET O. WHITMILL, R.L.A., INC.	DEPARTMENT OF		·	
				P.O. BOX 5212	ROAD NO.	COUNTY	FINANCIAL PROJECT ID	
				JACKSONVILLE, FL 32247-7688	SR 212	DUVAL	431962-1-52-01	

IRRIGATION DETAILS

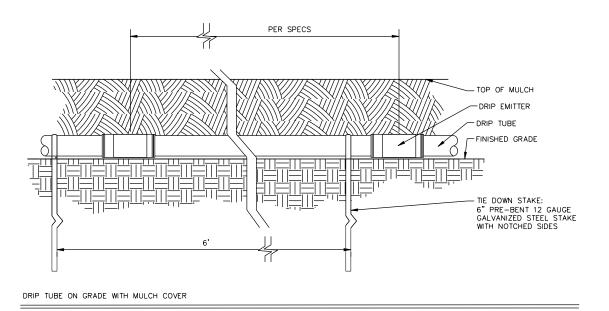
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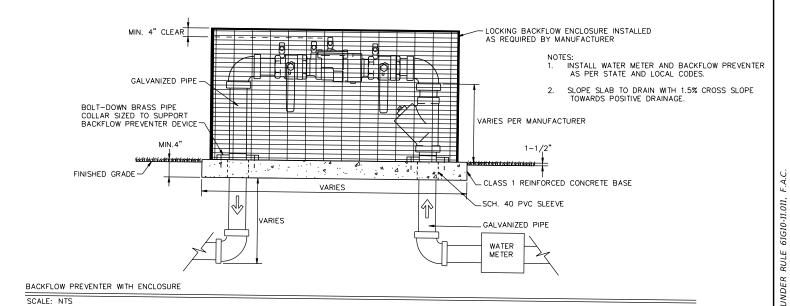
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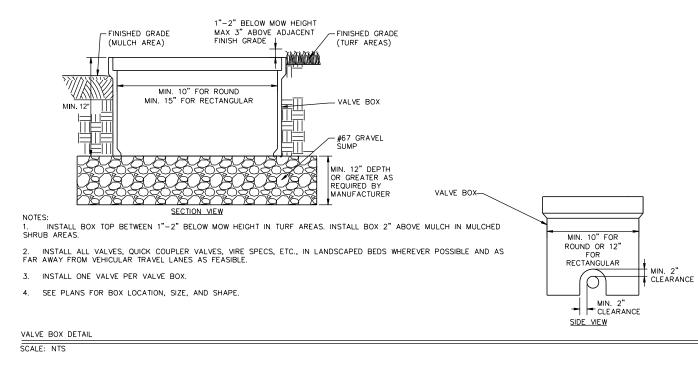
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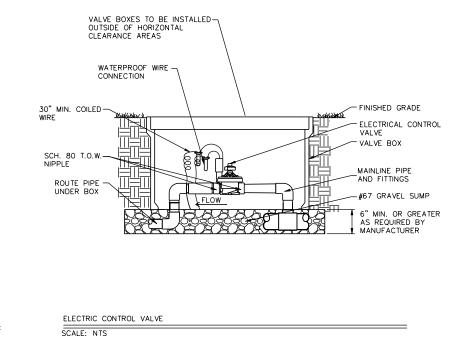
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NOTICE: THE OFFICIAL RECORD OF THIS SHEET IS THE ELECTRONIC FILE DIGITALLY SIGN





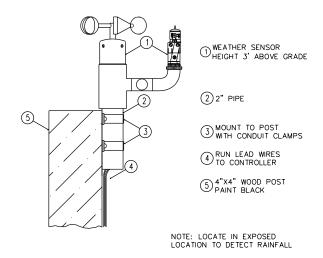




REVISIONS JANET O. WHITMILL, R.L.A. STATE OF FLORIDA DESCRIPTION R.L.A. NO.: 1289 DESCRIPTION DATE DEPARTMENT OF TRANSPORTATION JANET O. WHITMILL, R.L.A., INC. P.O. BOX 5212 ROAD NO. COUNTY FINANCIAL PROJECT ID JACKSONVILLE, FL 32247-7688 SR 212 **DUV AL** 431962-1-52-01

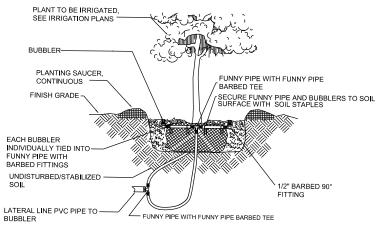
IRRIGATION DETAILS

SHEET NO.



WEATHER SENSOR

SCALE: NTS



FINISHED GRADE

ISOLATION VALVE

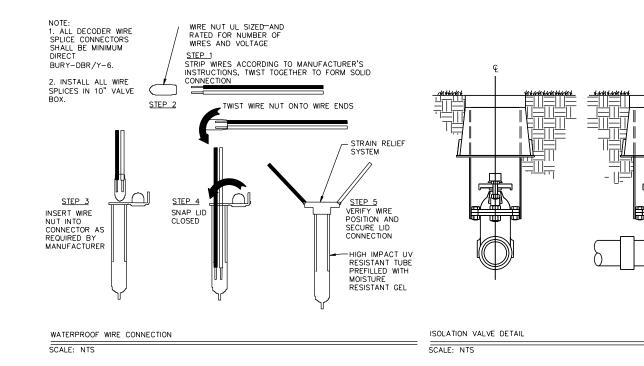
- NOTES:

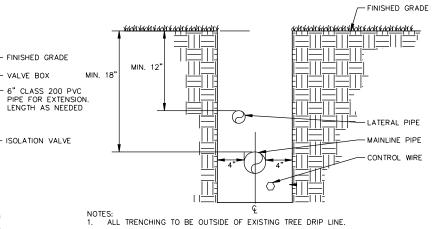
 1. BUBBLERS SHALL BE PLACED ON THE UPHILL SIDE OF ANY SLOPES & ON THE OPPOSING SIDES OF EACH ROOTBALL WITHIN THE SAUCER

 2. BUBBLERS TO BE INSTALLED ADJACENT TO ROOTBALL PERIMETER, DO NOT INSTALL BUBBLER ON TOP OF ROOTBALL OR NEXT TO
- REFER TO PLANS FOR BUBBLER FLOW VOLUME AND BUBBLER QUANTITIES PER TREE OR PALM

BUBBLER APPLICATION

SCALE: NTS





- 2. NO ROCKS, BOULDERS, OR SHAPR OBJECTS TO BE IN TRENCH BACKFILL.
- ALL PIPE TO BE INSTALLED AS RECOMMENDED BY MANUFACTURER.
- 4. AT EACH CHANGE IN MAINLINE DIRECTION INSTALL A 30" LOOP OF EXTRA WIRE.
- 5. BUNDLE WIRE WITH ELECTRICAL TAPE EVERY 10'.

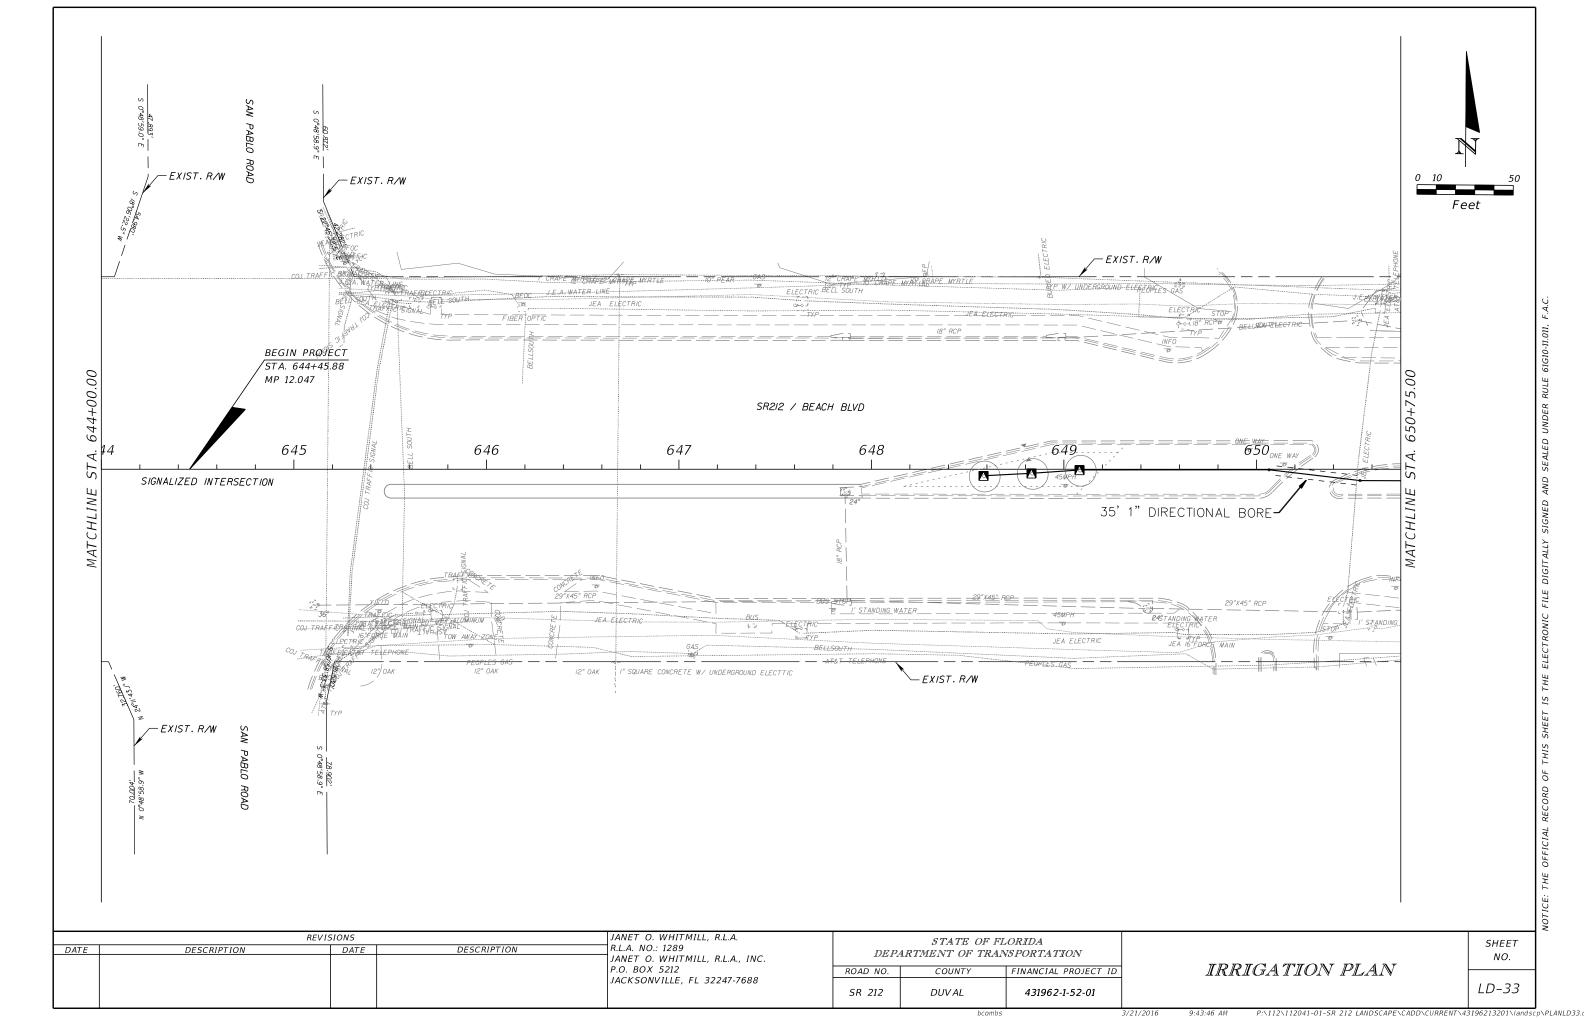
TRENCH, PIPE, AND WIRE DETAIL IN LANDSCAPE AREAS

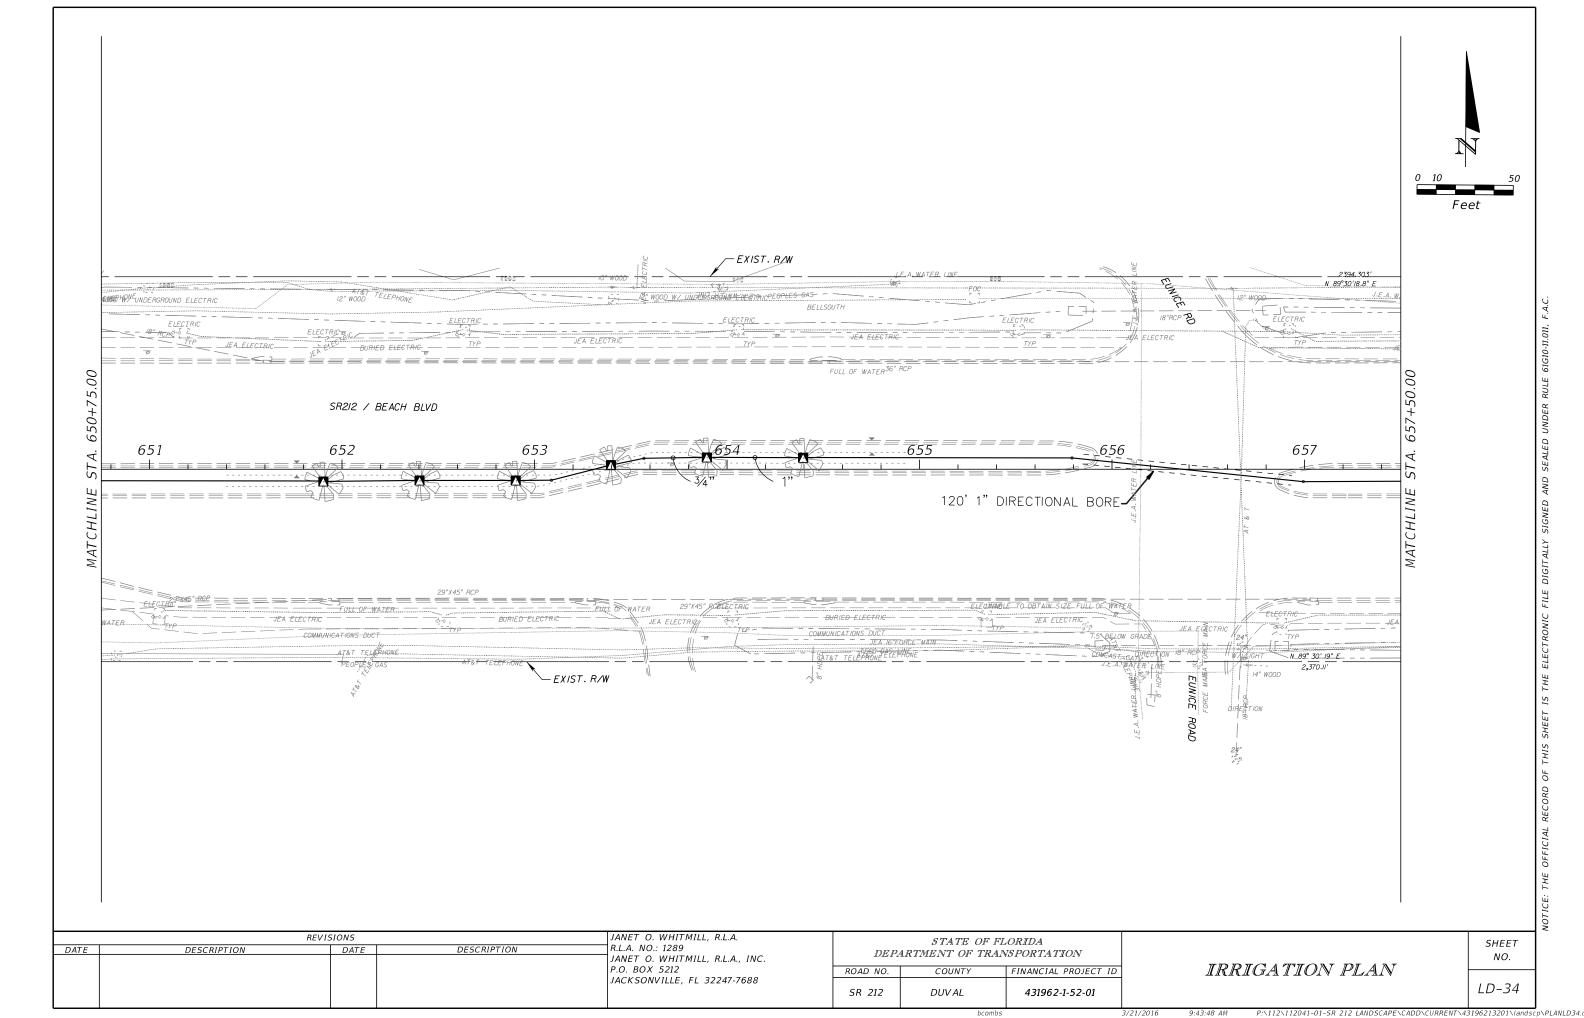
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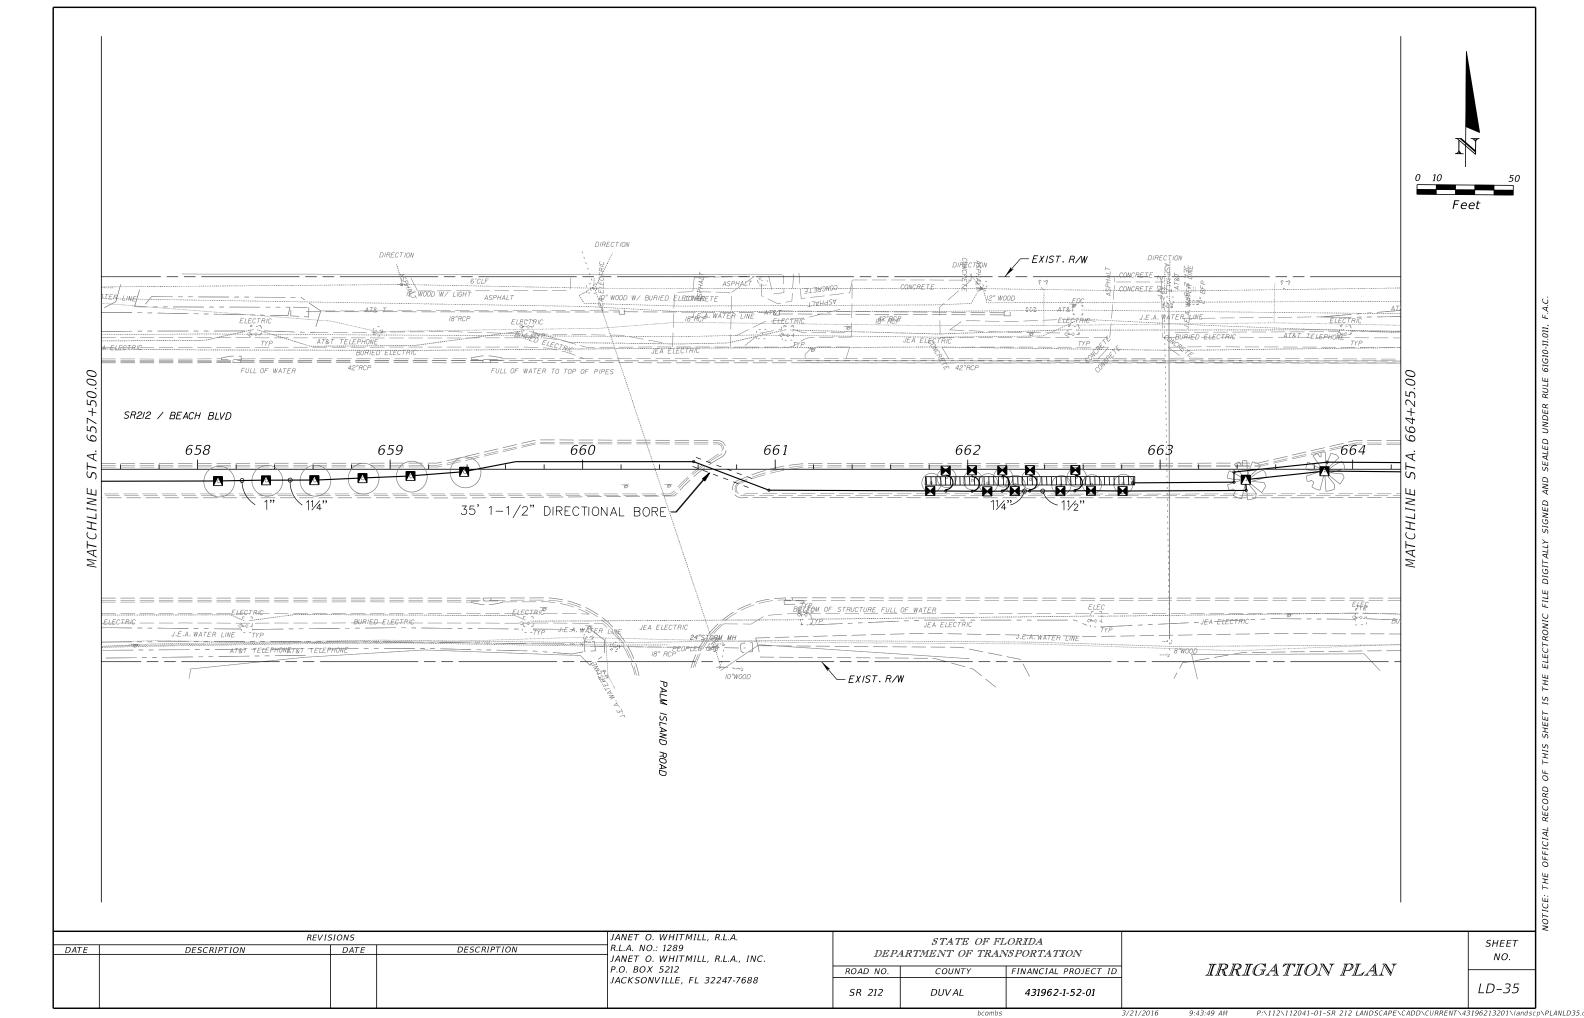
REVISIONS				JANET O. WHITMILL, R.L.A.	STATE OF FLORIDA		
DATE	DESCRIPTION	DATE	DESCRIPTION	R.L.A. NO.: 1289 JANET O. WHITMILL, R.L.A., INC.	DEPA	DEPARTMENT OF TRANSPORTATION	
				P.O. BOX 5212	ROAD NO.	COUNTY	FINANCIAL PROJECT ID
				JACKSONVILLE, FL 32247-7688	SR 212	DUVAL	431962-1-52-01

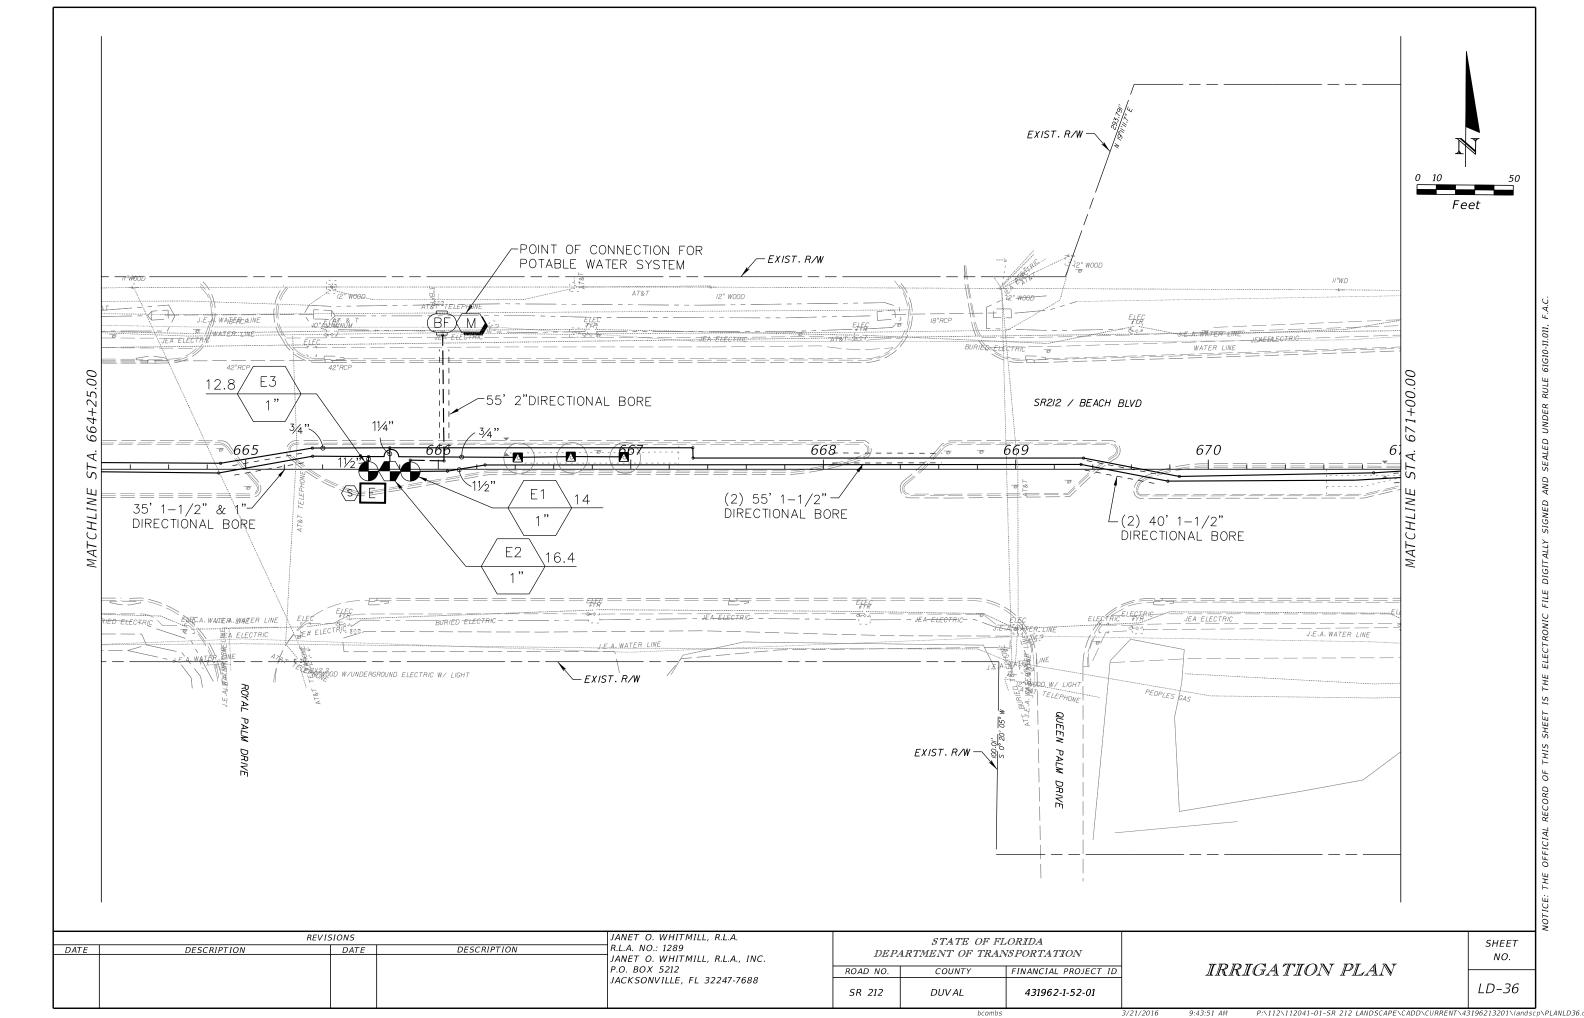
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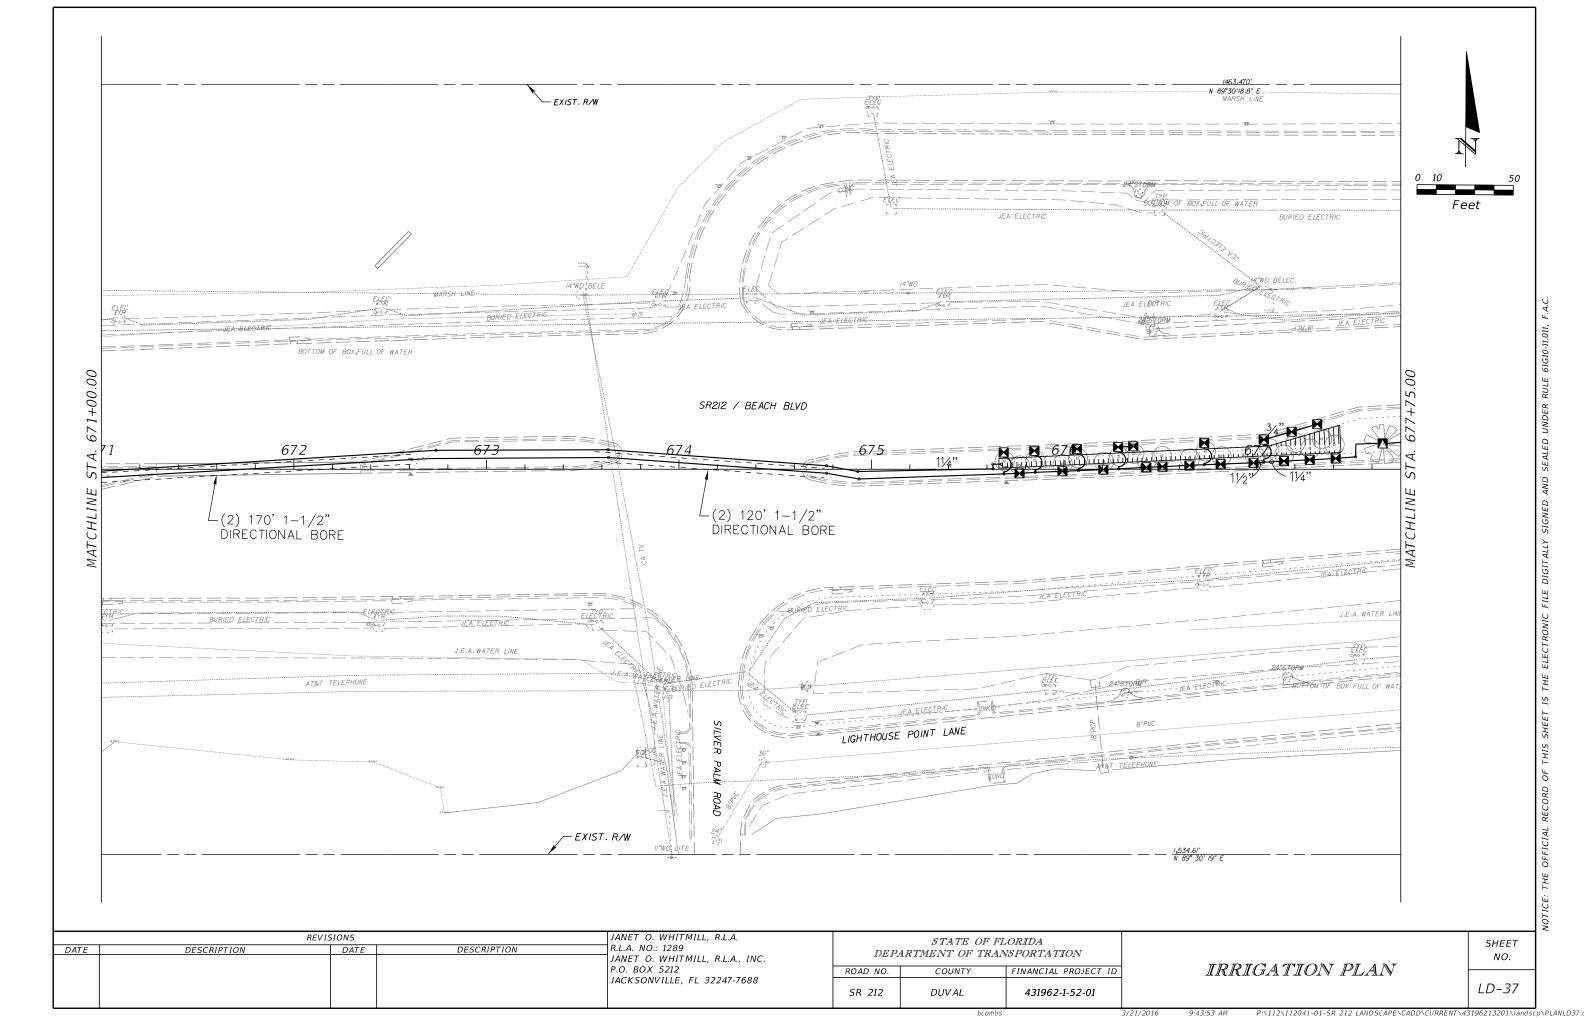
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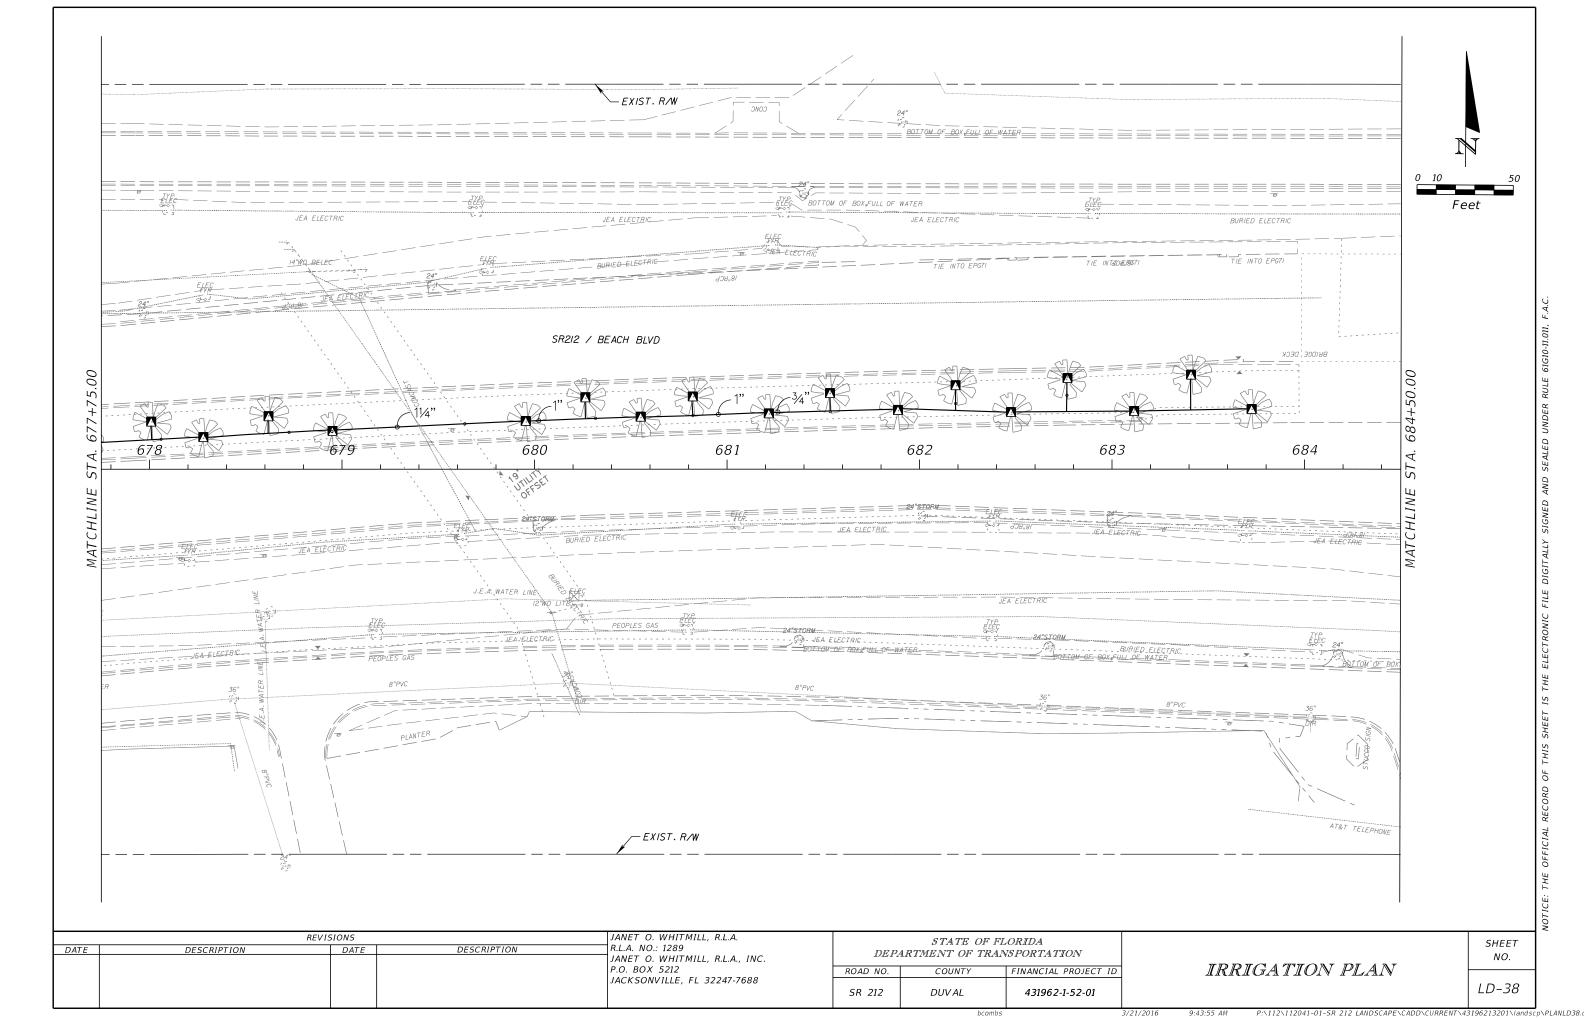


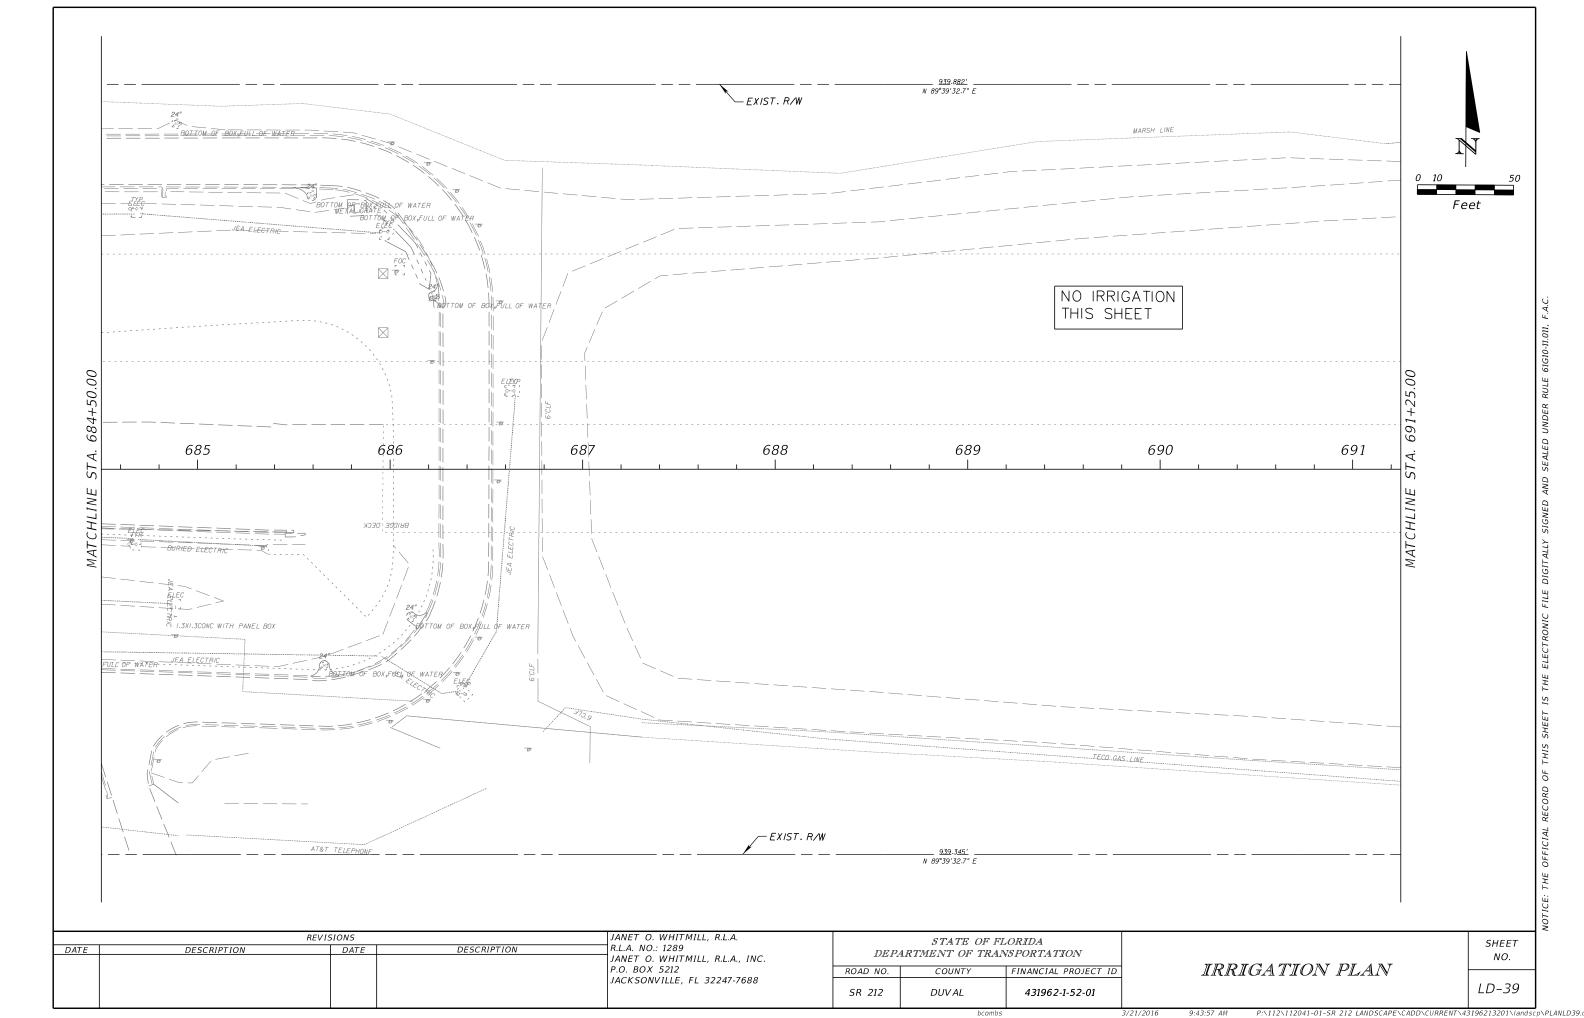


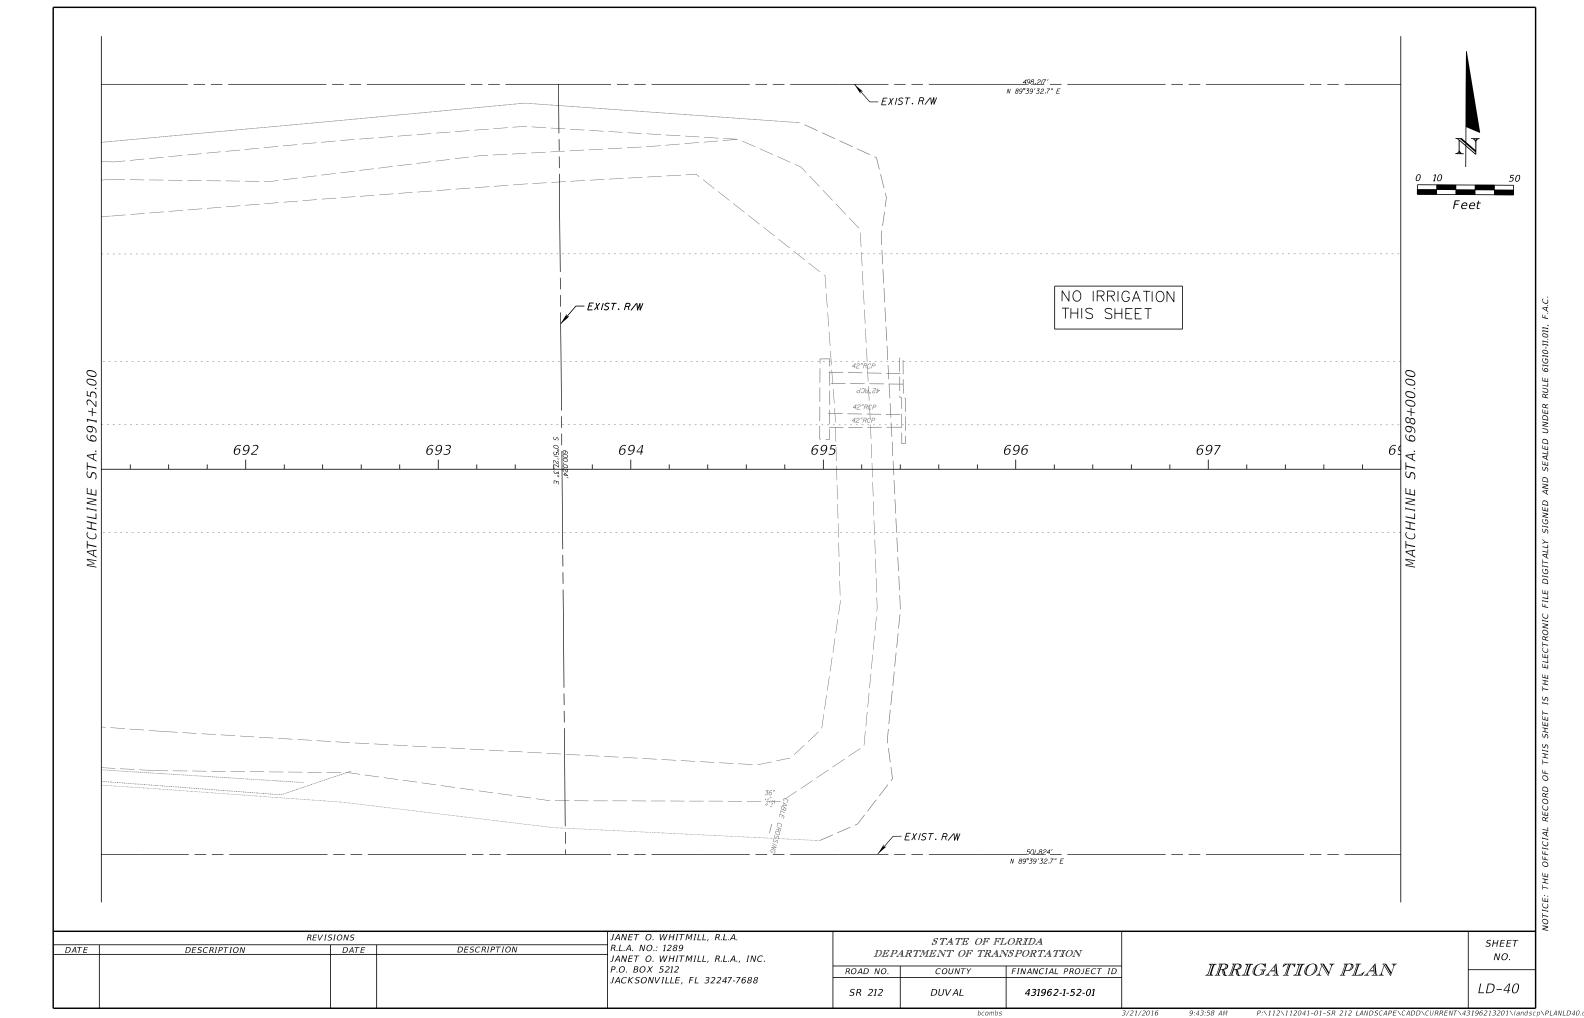


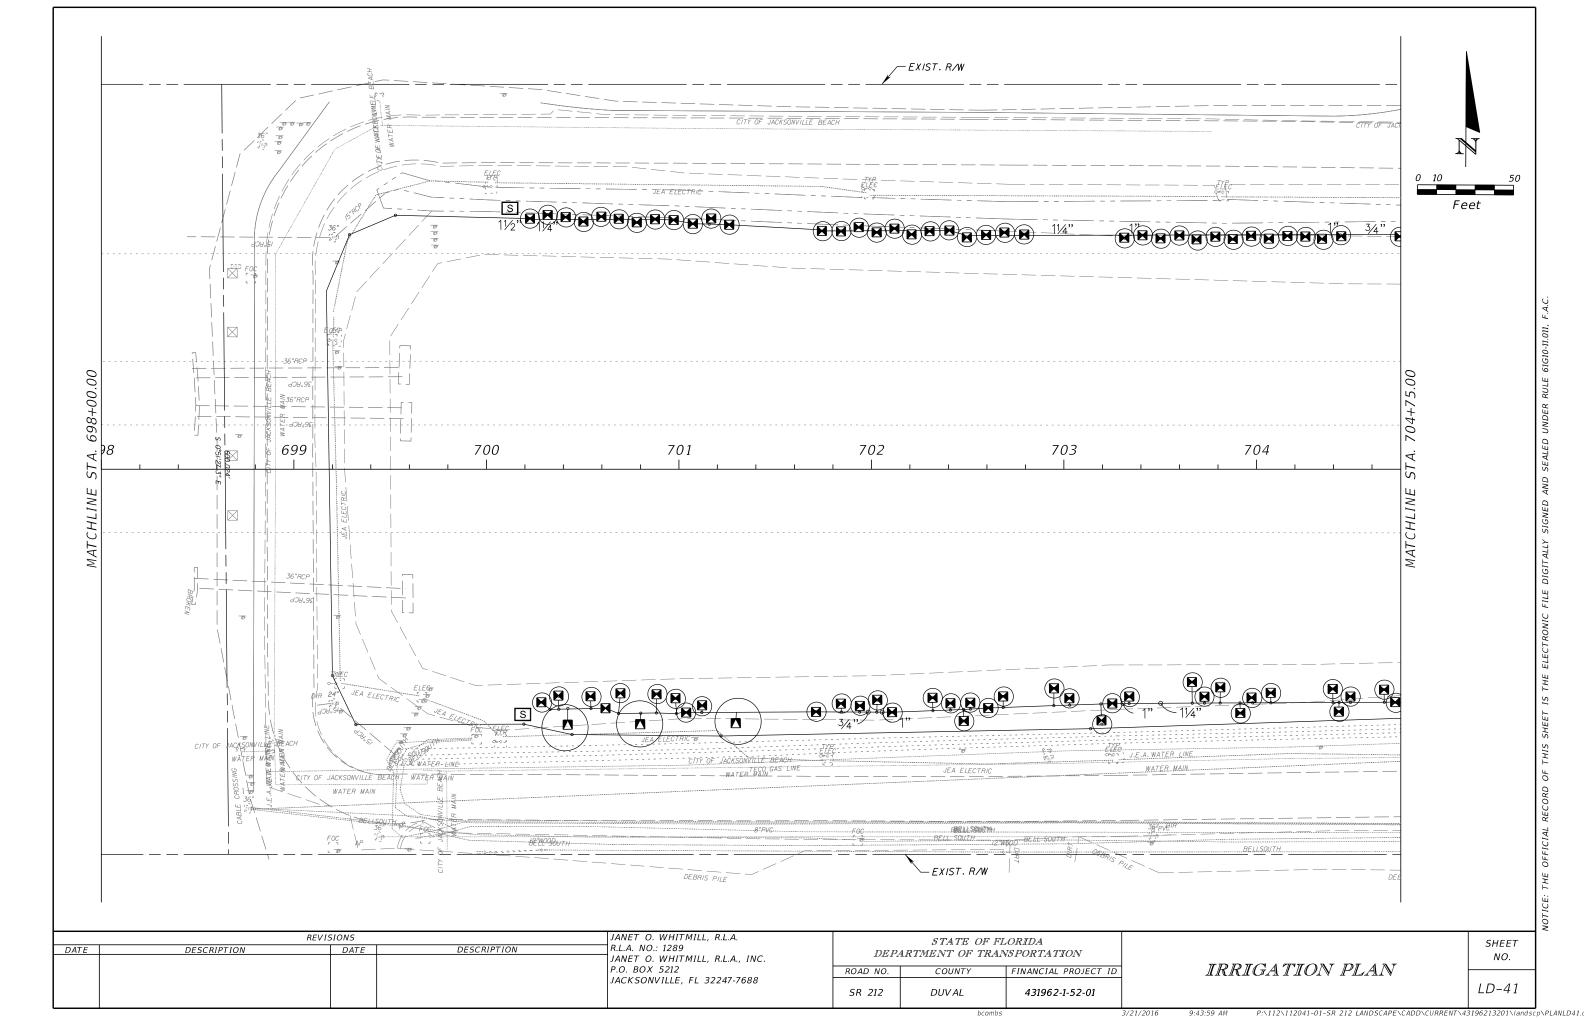


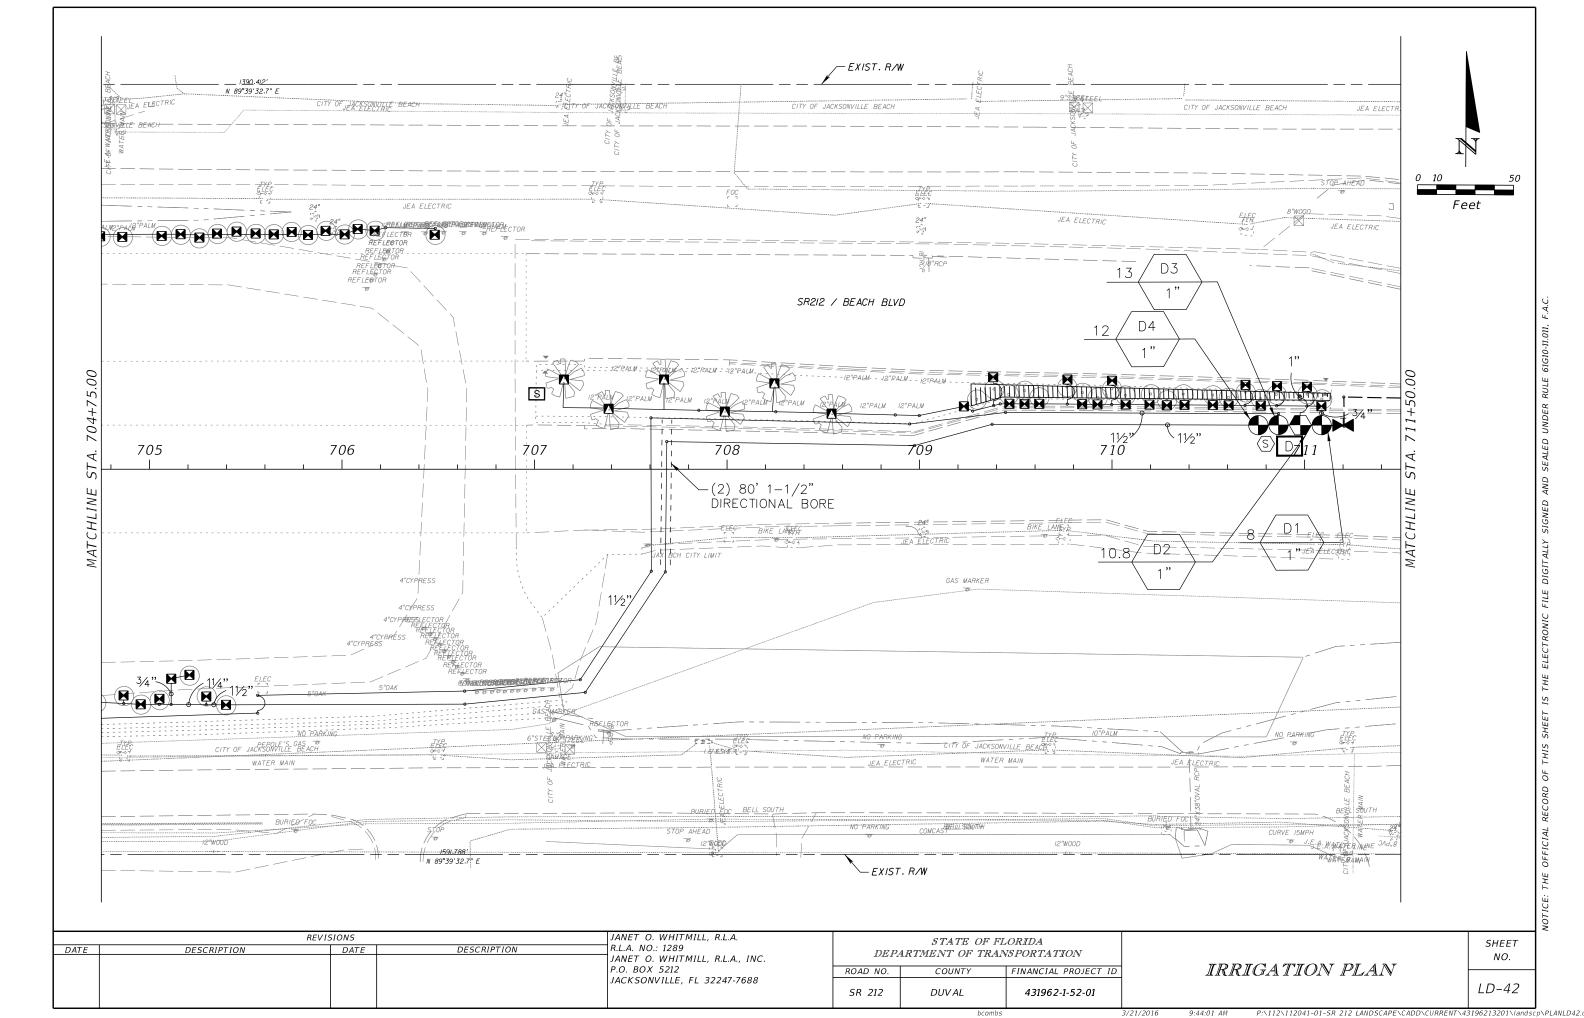


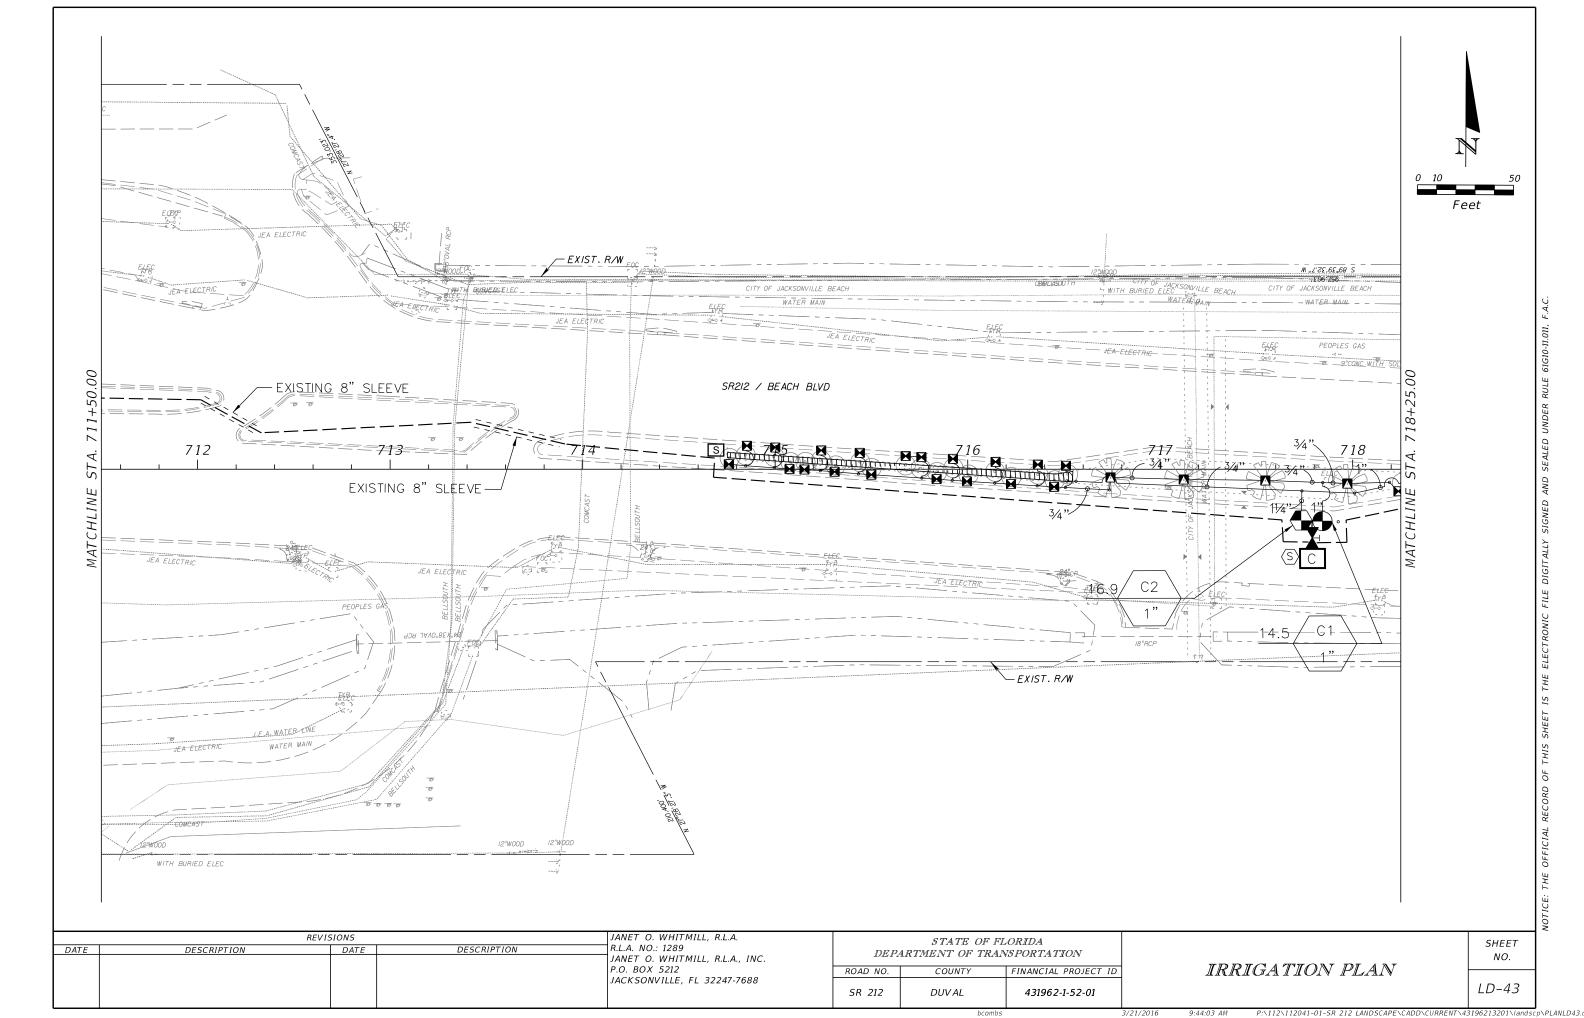


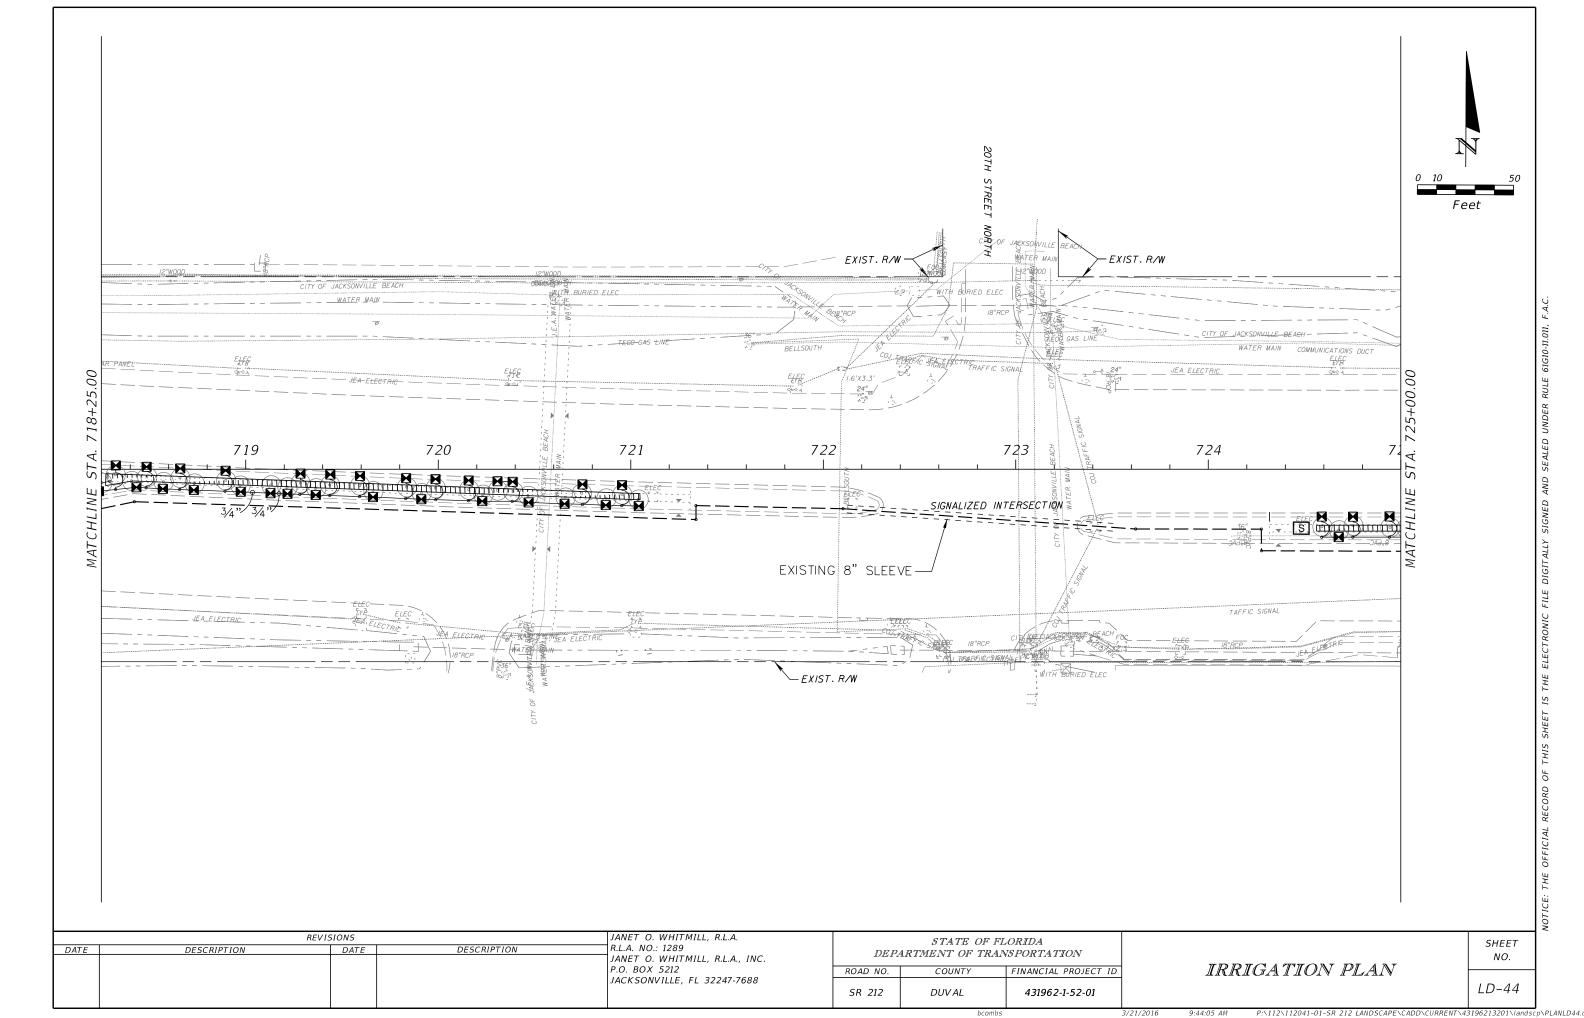


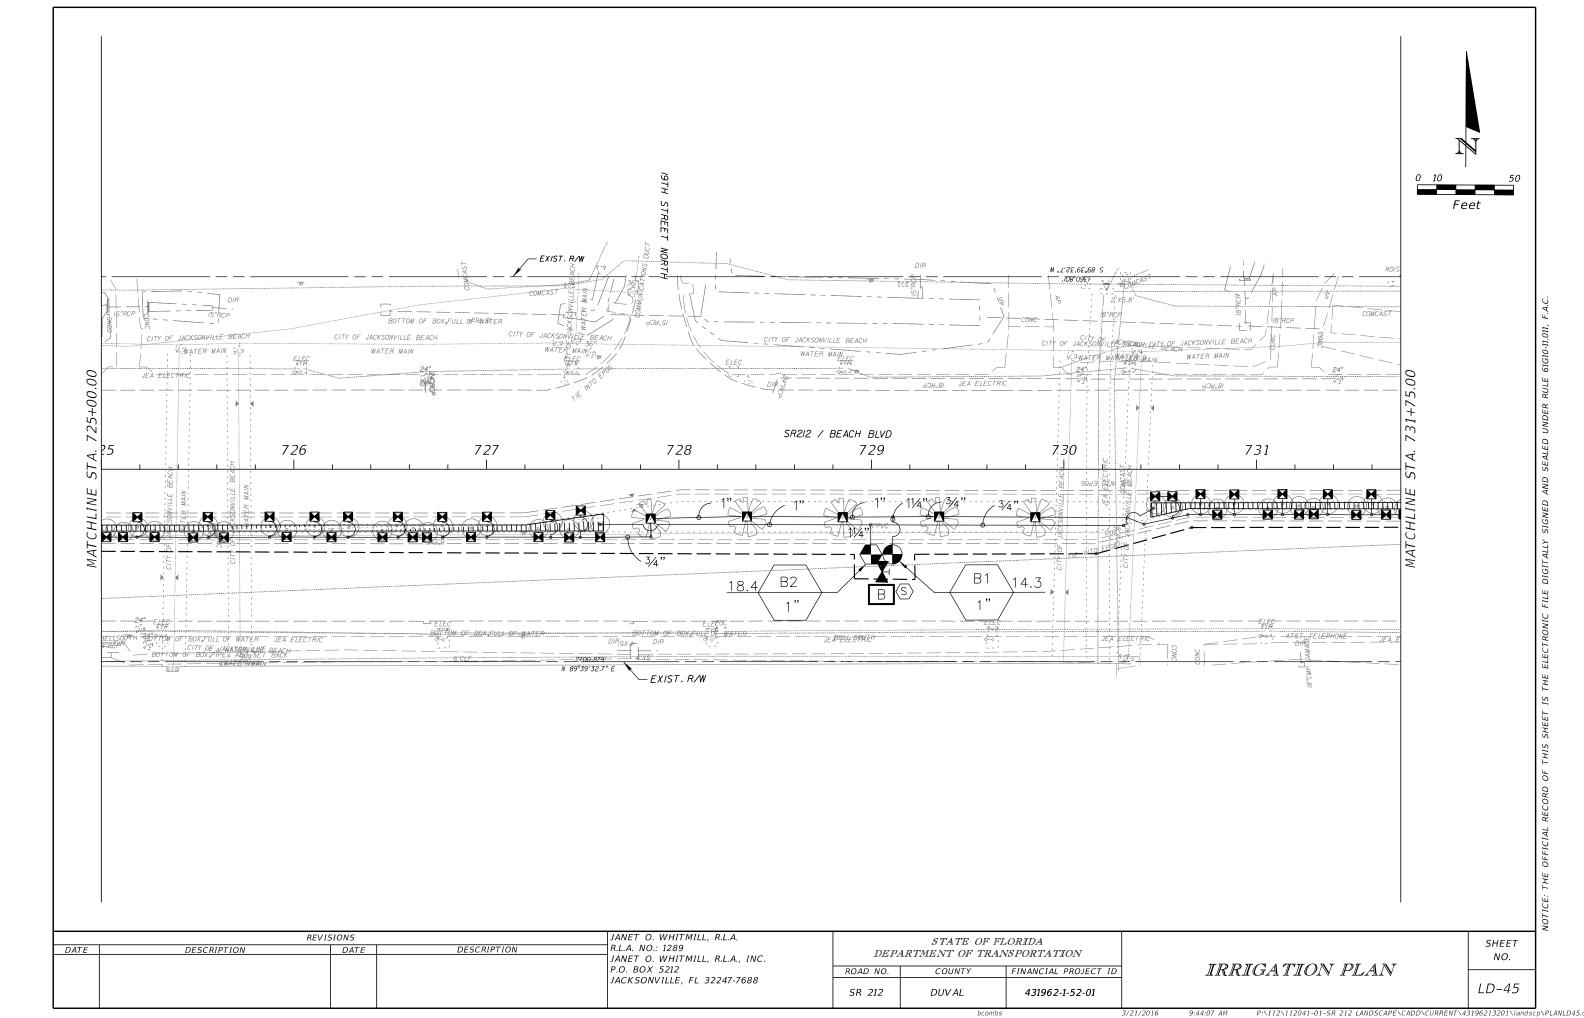


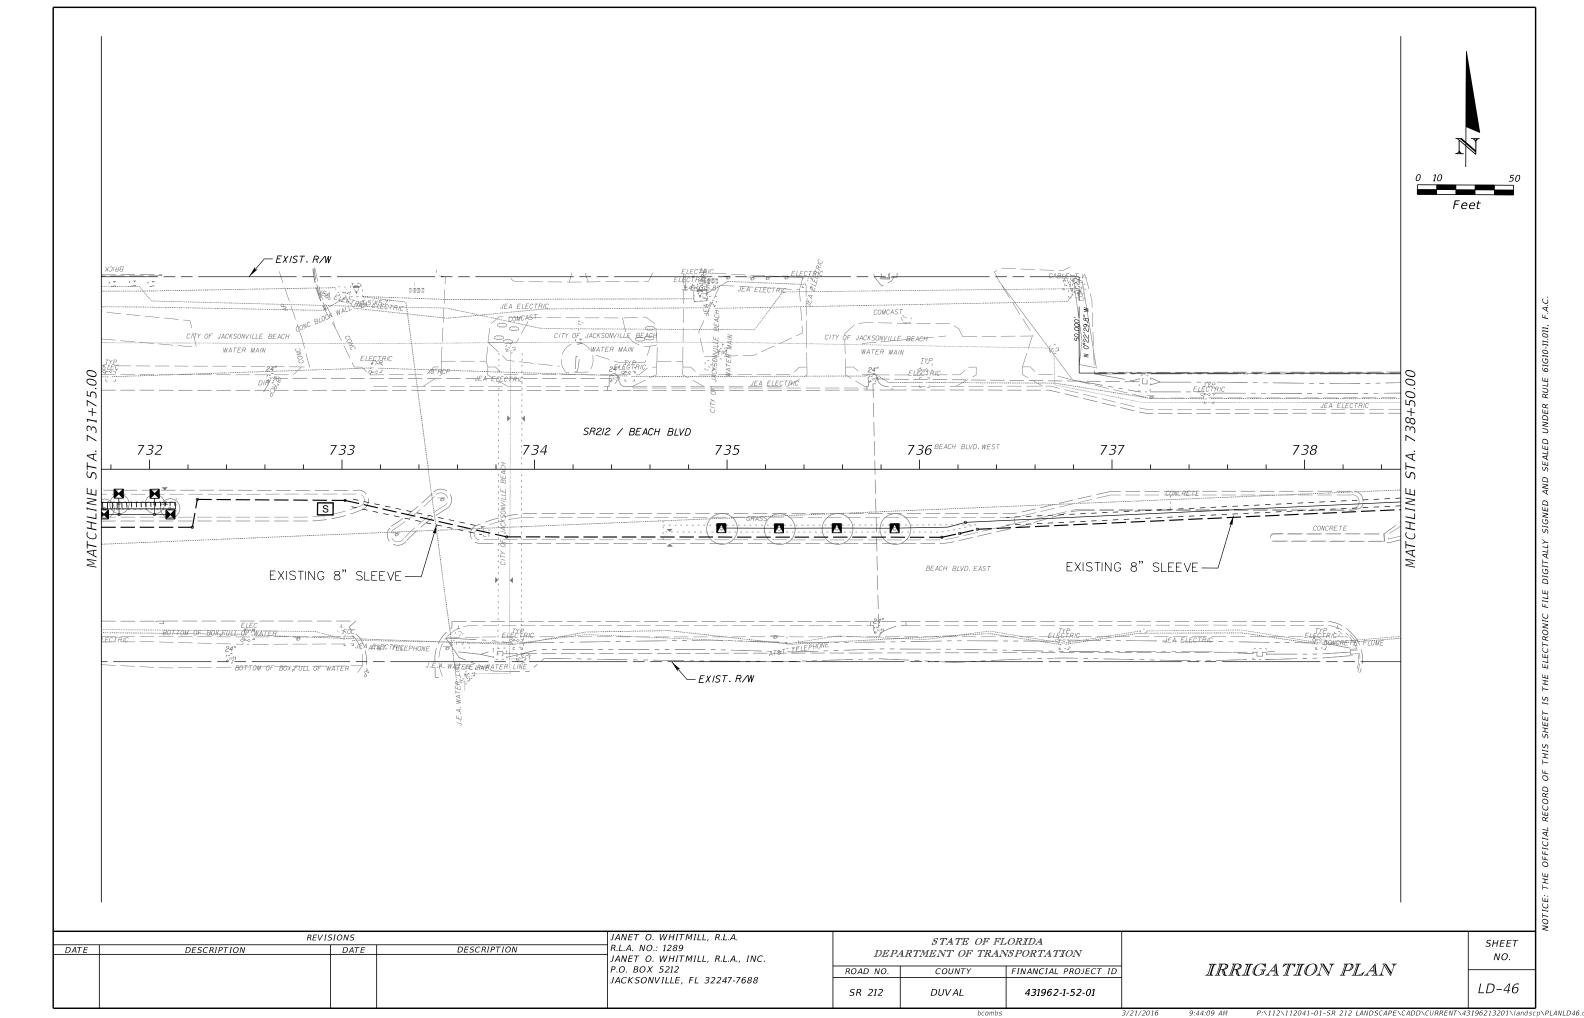


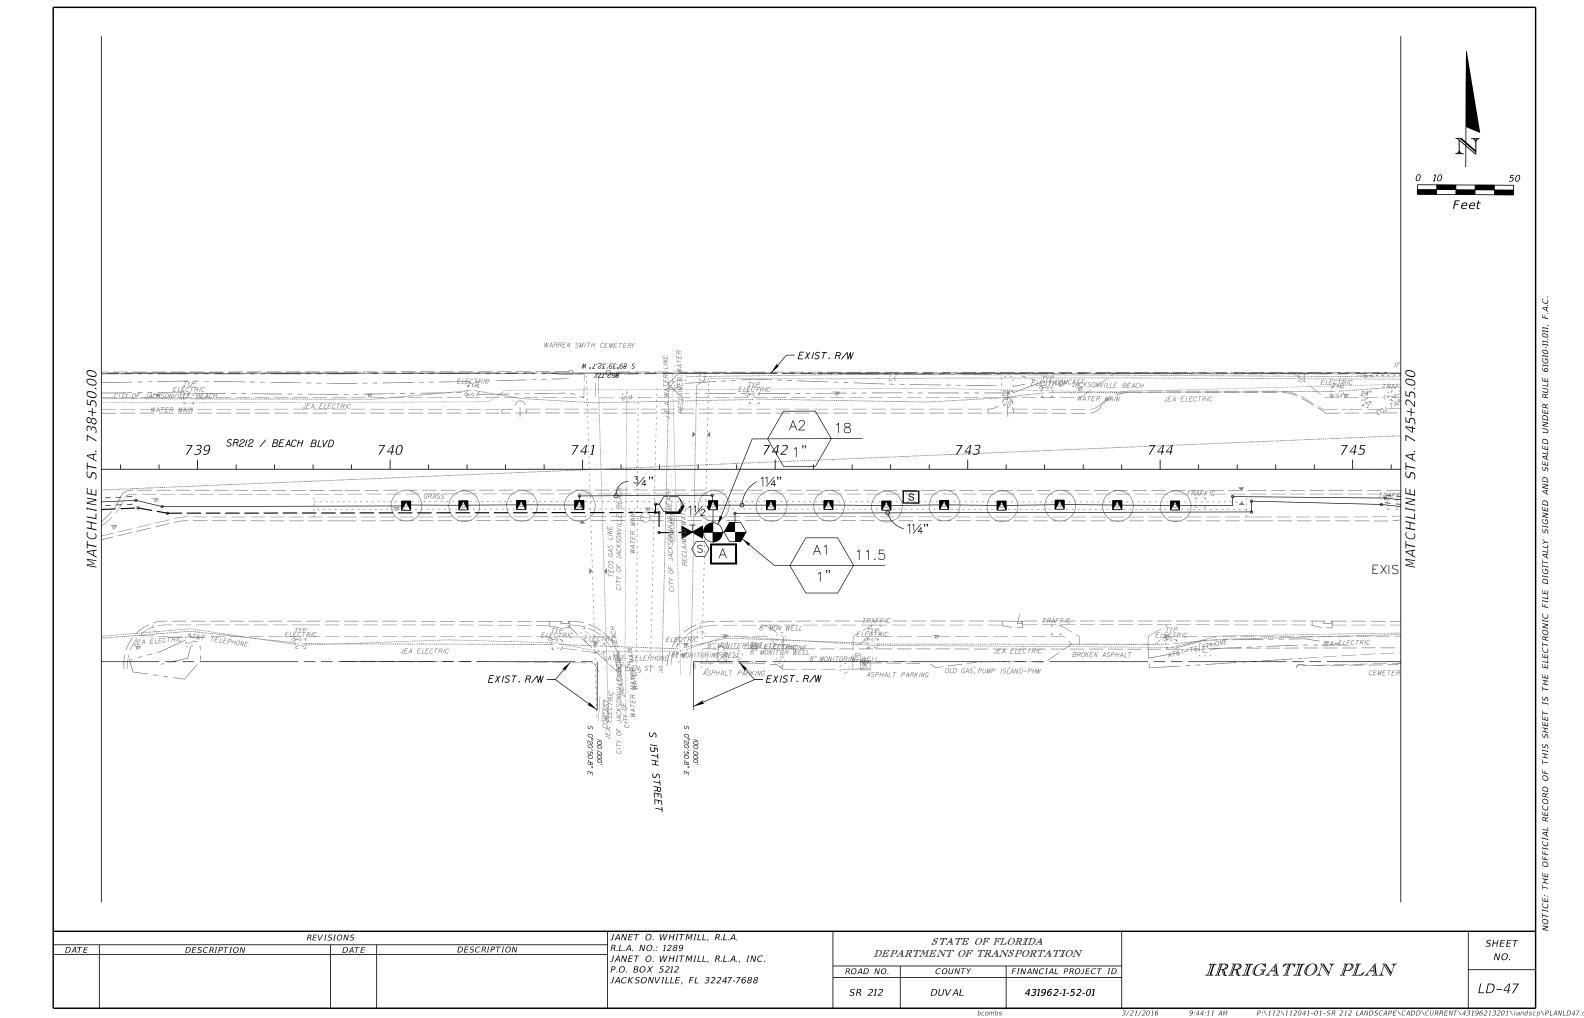


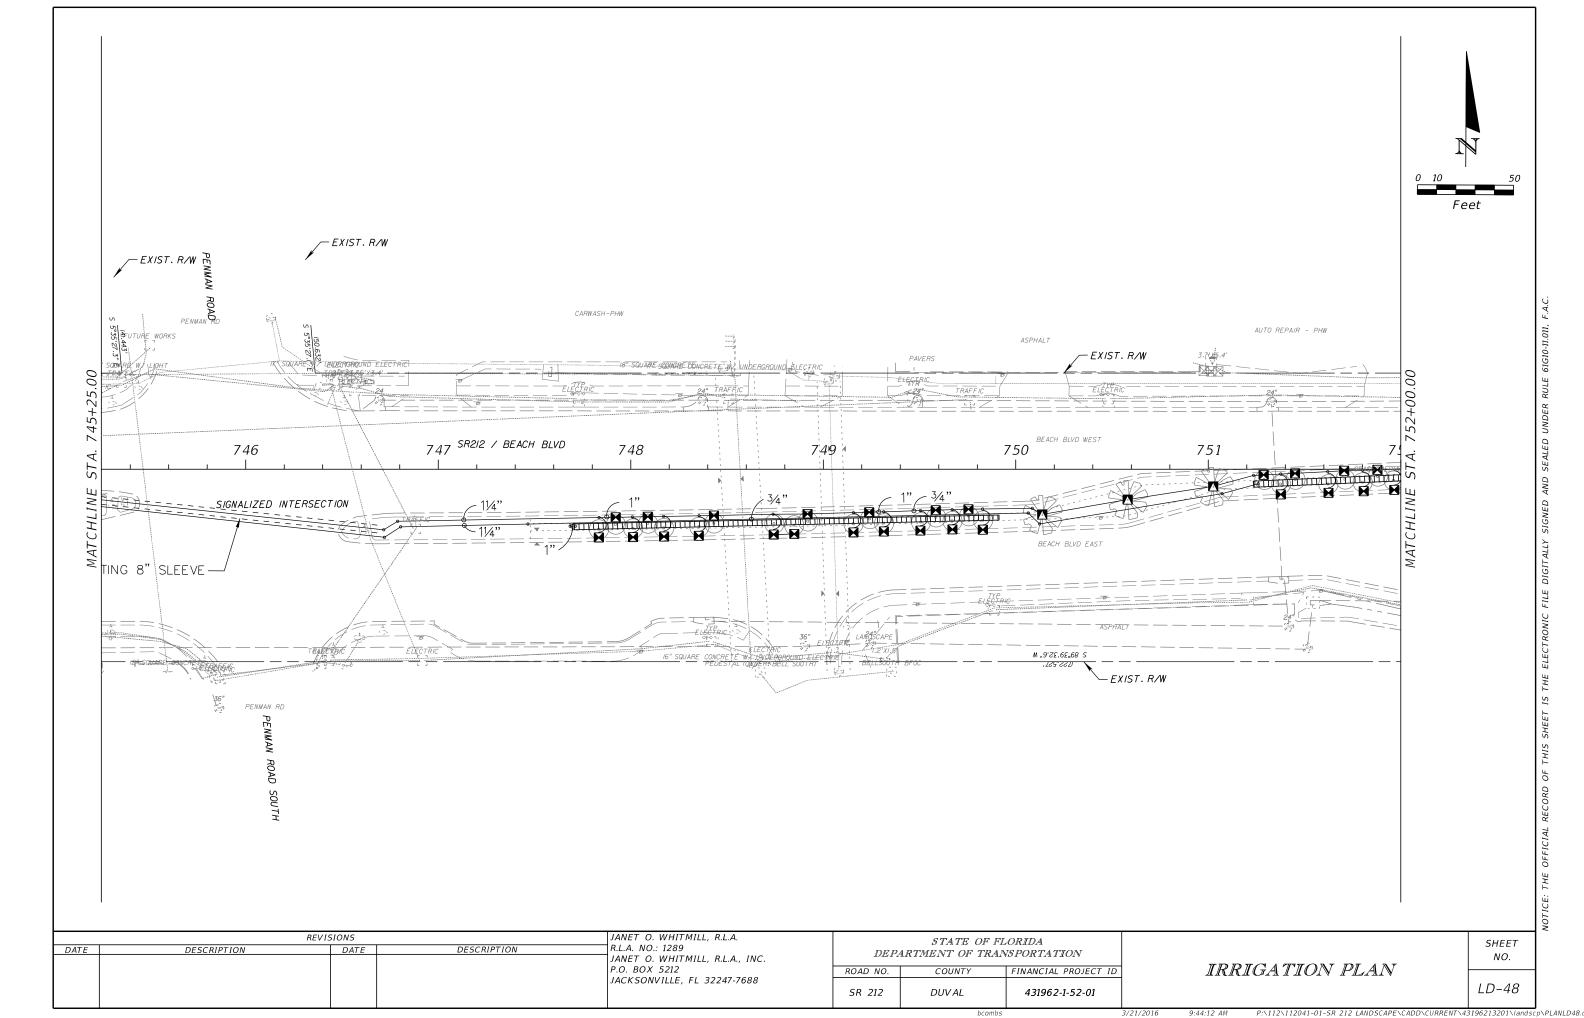


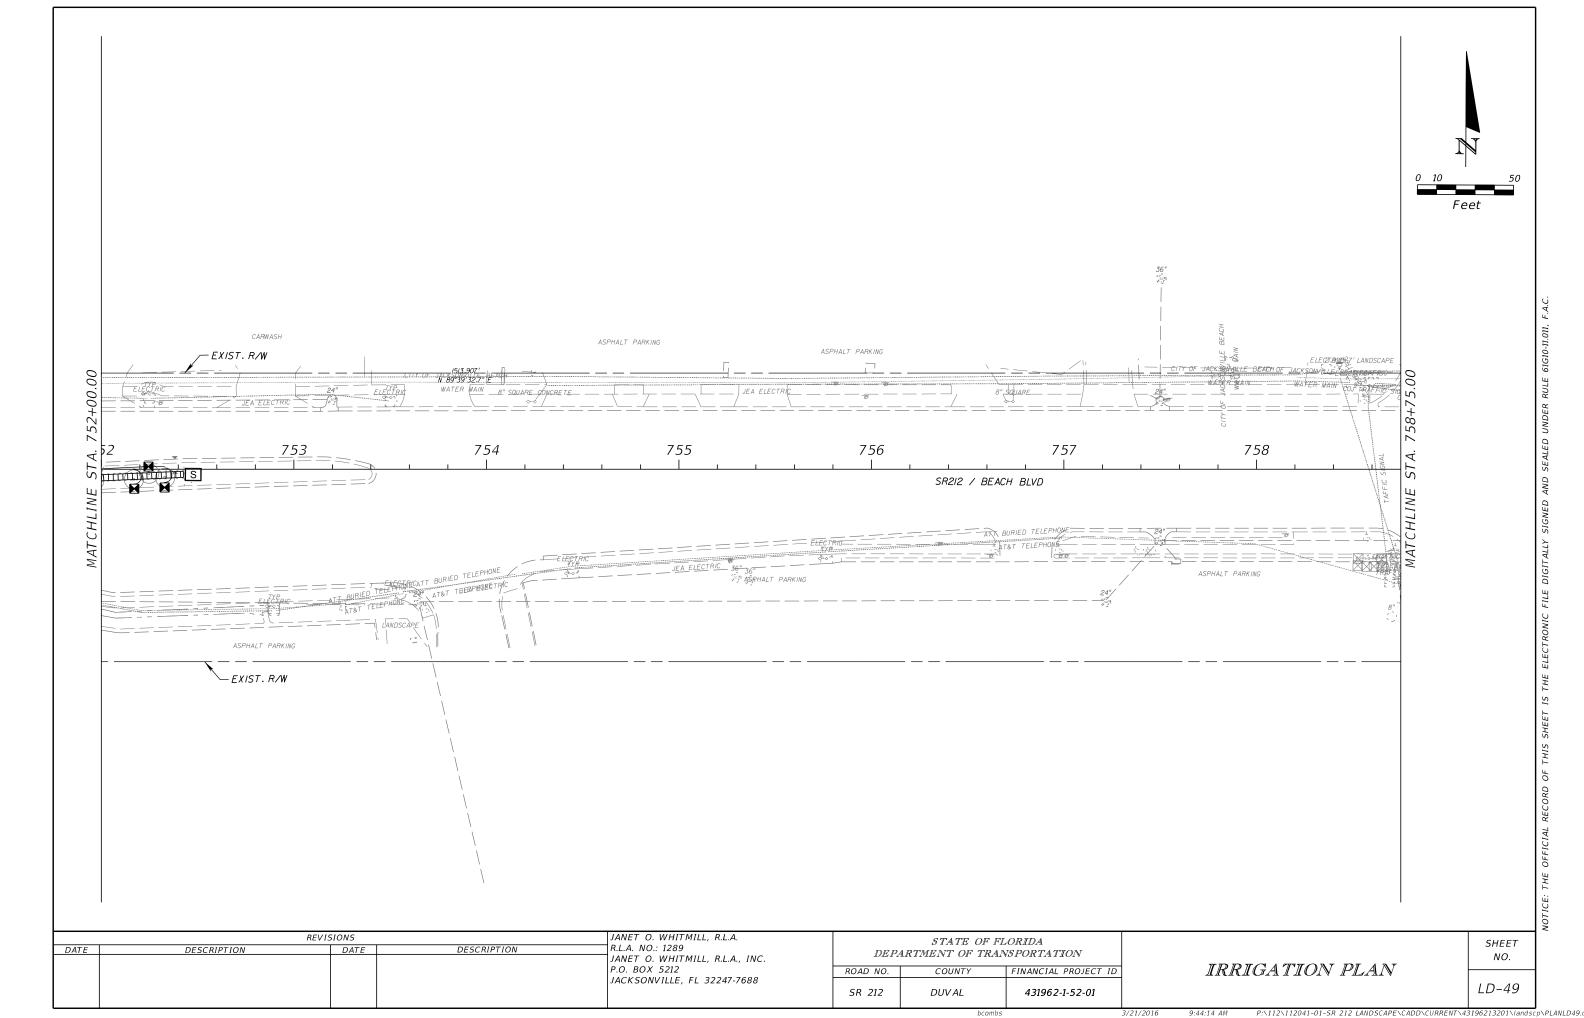


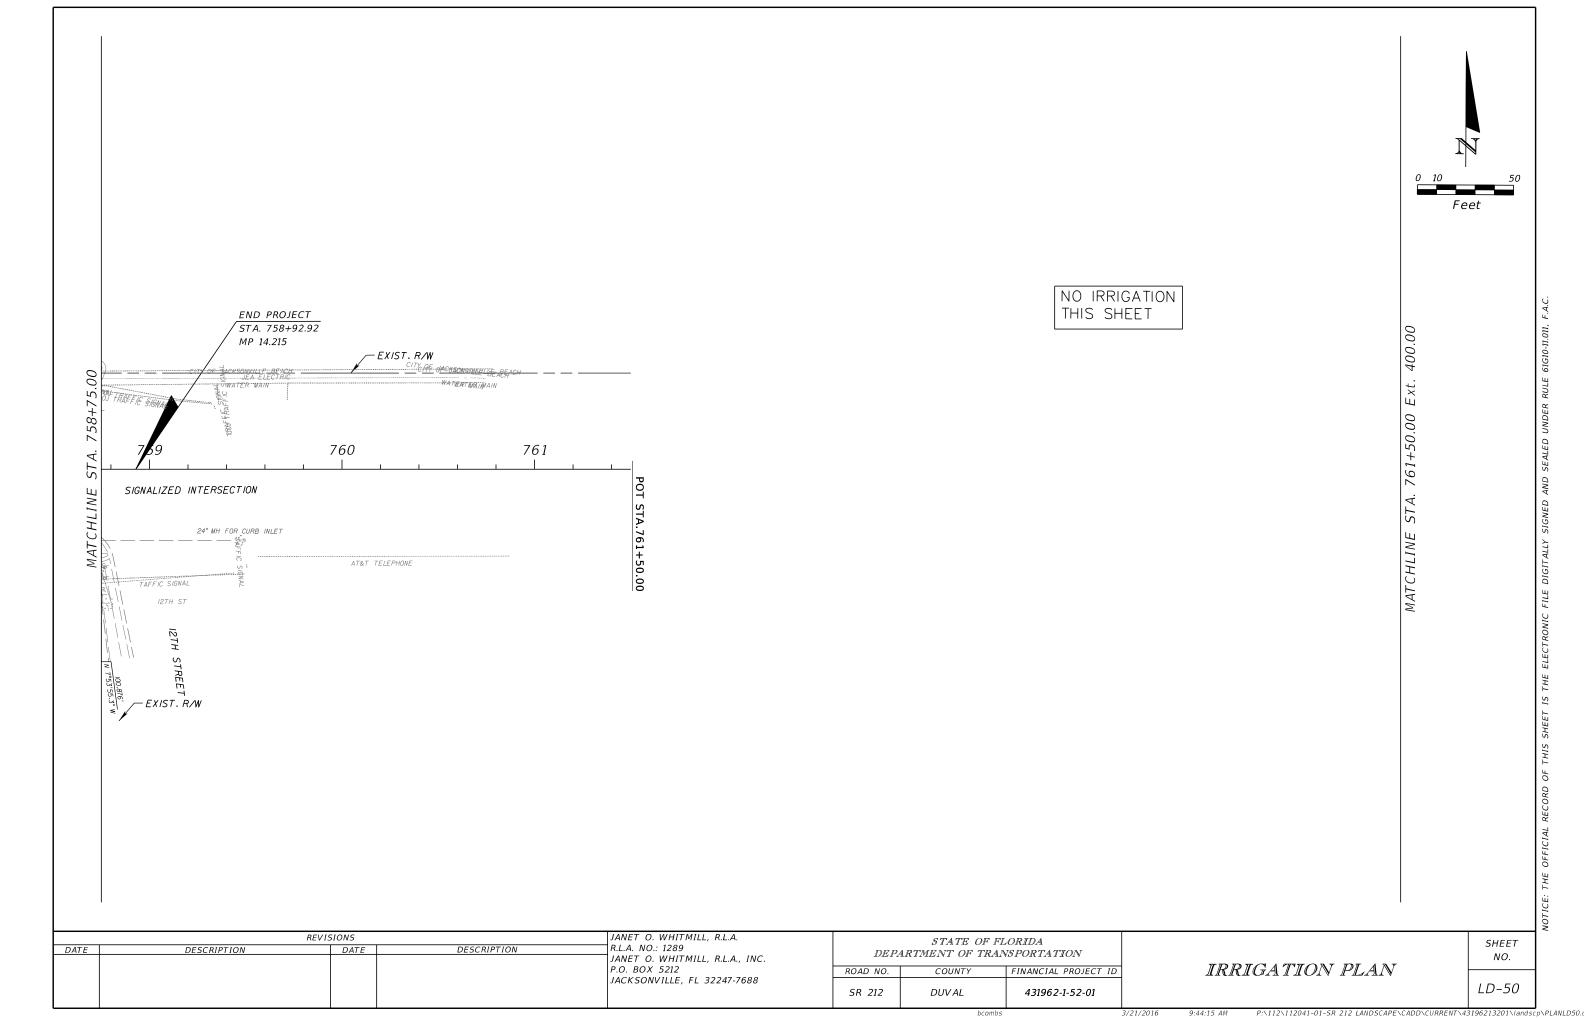












I. A. NATURE OF CONSTRUCTION ACTIVITY

THIS PROJECT CONSISTS OF THE INSTALLATION OF LANDSCAPING ITEMS IN SELECTED LOCATIONS ALONG SR 212 FROM SAN PABLO ROAD TO 12TH STREET IN DUVAL COUNTY, A DISTANCE OF 2.168 MILES.

I. B. SEQUENCE OF MAJOR SOIL DISTURBING ACTIVITIES I) CLEARING AND GRUBBING 2) INSTALLATION OF LANDSCAPING ITEMS

I. C. AREA ESTIMATES TOTAL SITE AREA: 116,160 SY (24 ACRES) TOTAL AREA DISTURBED: 14,520 SY (3 ACRES)

I. D. RUNOFF COEFFICIENTS

THE LANDSCAPING WORK WILL NOT CHANGE THE RUNOFF COEFFICIENTS BEFORE, DURING OR AFTER; THERE ARE NO ADDITIONAL IMPERVIOUS AREAS BEING ADDED. THE RUNOFF COEFFICIENT IN THE DISTURBED AREAS IS ANTICIPATED

URBAN LAND - THIS SOIL IS LOCATED IN AREAS WHERE MORE THAN 85 PERCENT OF THE SURFACE IS COVERED BY STREETS, SIDEWALKS, AND OTHER STRUCTURES, THE NATURAL SOIL CANNOT BE OBSERVED, THE SOILS IN OPEN AREAS, MAINLY VEGETATED HIGHWAY BORDER AREAS HAVE BEEN ALTERED BY LAND GRADING AND SHAPING. AREAS OF THESE SOILS ARE SO SMALL THAT MAPPING THEM SEPARATELY IS IMPRACTICAL NO CAPABILITY CLASSIFICATION IS

I. E. SITE MAP

THE CONSTRUCTION PLANS SERVE AS THE SITE MAP. THE LOCATION OF THE REQUIRED INFORMATION IS DESCRIBED BELOW AND ON THE KEY MAP: DRAINAGE PATTERNS: THE ATTACHED LANDSCAPE PLAN SHEETS SHOW THE INLETS THAT RECEIVE THE STORMWATER FROM THE DISTURBED AREAS. ALL RUNOFF FROM THE PROJECT SITE IS DIRECTED TOWARD INLETS WITHIN THE RIGHT OF WAY FOR TREATMENT WITHIN THE EXISTING SYSTEM. (SEE THE LANDSCAPE PLANS)

APPROXIMATE SLOPES: VARY; HOWEVER, THE EXISTING SLOPES ARE TO REMAIN

AREAS OF SOIL DISTURBANCE: 3.735 AC

AREAS NOT TO BE DISTURBED: 70.399 AC

LOCATIONS OF TEMPORARY CONTROLS: AT EXISTING INLETS. LOCATIONS OF PERMANENT CONTROLS; EXISTING CONTROLS REMAIN. INLETS, SWALES, BERMS, WALLS, CURB AND GUTTER, ETC. AREAS TO BE STABILIZED; ALL DISTURBED AREAS WILL BE PERMANENTLY STABILIZED WITH LANDSCAPING ITEMS. SURFACE WATERS: INTRACOASTAL WATERWAY DISCHARGE POINTS TO SURFACE WATERS: VIA SWALES, OUTFALLS AND WETLAND AREAS: THERE ARE NO WETLANDS.

I. F. RECEIVING WATERS

OUTFALL INFORMATION LOCATION: SEE THE LATITUDE AND LONGITUDE BELOW. LATITUDE: 30 DEGREES 17 MINUTES 17 SECONDS NORTH LONGITUDE: 81 DEGREES 25 MINUTES 17 SECONDS WEST RECEIVING WATER NAME: INTRACOASTAL WATERWAY DRAINAGE AREA: UNKNOWN; HOWEVER, NO CHANGES WILL RESULT FROM THIS PROJECT.

2.0 CONTROLS

2. A. EROSION AND SEDIMENT CONTROLS IN THE SECTION 104 EROSION CONTROL PLAN, THE CONTRACTOR SHALL DESCRIBE THE PROPOSED STABILIZATION AND STRUCTURAL PRACTICES BASED ON THE CONTRACTOR'S CONSTRUCTION PHASING PLAN, THE CONTRACTOR MAY CHOOSE TO ACCEPT THE FOLLOWING GUIDELINES OR MODIFY THE SECTION 104 EROSION CONTROL PLAN, SUBJECT TO APPROVAL OF THE ENGINEER, AS WORK PROGRESSES. THE CONTRACTOR SHALL MODIFY THE PLAN TO ADAPT TO SEASONAL VARIATION, CHANGES IN CONSTRUCTION ACTIVITIES AND THE NEED FOR BETTER PRACTICES.

CONSTRUCTION ACTIVITIES - GENERAL THE MAJOR CONTROLS OUTLINED IN THIS SWPPP ARE SEDIMENT AND EROSION CONTROL THROUGH THE PHASING OF THE CONSTRUCTION OPERATION THEREBY LIMITING THE AMOUNT OF ERODIBLE EARTH EXPOSED AT ANY GIVEN TIME. REMOVAL OF EXCESS DIRT ON THE PAVED AREAS AND THE PROTECTION OF THE EXISTING INLETS AND OUTFALLS. MAJOR EROSION PROBLEMS ARE NOT ANTICIPATED DUE TO THE NATURE OF THE PROJECT WORK. GOOD HOUSEKEEPING, EQUIPMENT MAINTENANCE AND WORK PROGRESS ARE INTEGRAL PARTS OF THIS PLAN.

PRIOR TO EXPOSING ERODIBLE EARTH, SILT FENCE WILL BE INSTALLED AT THE CURB INLETS AND BACK OF CURBED MEDIANS AND EDGE PLANTING AREA OF HOPSON ROAD TO PRECLUDE THE DISCHARGE OF SILT LADEN CONSTRUCTION WATERS INTO THE DRAINAGE SYSTEM.

LANDSCAPING AREAS WILL NOT BE CLEARED UNTIL THE PLANTING MATERIALS ARE AVAILABLE FOR A PARTICULAR SITE. CONTROLLING THE AMOUNT OF ERODIBLE EARTH EXPOSED AT ANY GIVEN TIME WILL REDUCE THE POTENTIAL FOR SEDIMENT TRANSPORT

PLANTINGS, SODDING AND MULCHING WILL BEGIN WITHIN 7 DAYS OF FINAL GRADING AND SITE PREPARATION ACTIVITIES.

STOCKPILED MATERIALS WILL NOT BE STORED ON SITE FOR MORE THAN 24 HOURS PRIOR TO INSTALLATION NOR WILL THEY BE LOCATED ADJACENT TO WATER BODIES OR INLETS. SHOULD A SITUATION ARISE THAT REQUIRES THE MATERIAL TO BE STOCKPILED FOR MORE THAN 24 HOURS, SEDIMENT CONTROLS WILL BE PROVIDED TO REDUCE THE POTENTIAL FOR SEDIMENT TRANSPORT.

2. A.I STABILIZATION PRACTICES

STABILIZATION MEASURES WILL BE INITIATED AS SOON AS PRACTICAL BUT IN NO CASE MORE THAN 7 DAYS AFTER CONSTRUCTION ACTIVITIES HAVE TEMPORARILY OR PERMANENTLY CEASED. TEMPORARY: WATER EXPOSED SOILS, SEED, MULCH AND SOD IN ACCORDANCE WITH STANDARD SPECIFICATIONS SECTION 104.

2. A.2 STRUCTURAL PRACTICES

PERMANENT: MULCH, SOD, SHRUBS AND TREES

SEDIMENT CONTROLS WILL BE IN PLACE BEFORE DISTURBING SOIL UPSTREAM OF THE CONTROL. THE STRUCTURAL PRACTICES SHALL INCLUDE THE FOLLOWING.

TEMPORARY: INLET PROTECTION: FILTER FABRIC, SILT FENCE COST TO BE INCLUDED IN PAY ITEM 104-18, INLET PROTECTION OR 104-10-3

PERMANENT: EXISTING INLETS, SWALES AND DITCH BLOCKS/BERMS AND WALLS

2. B. STORMWATER MANAGEMENT

THE EXISTING STORMWATER MANAGEMENT DESIGN WILL NOT BE ALTERED.

2. C. OTHER CONTROLS

2. C.I WASTE DISPOSAL

IN THE SECTION 104 EROSION CONTROL PLAN, THE CONTRACTOR SHALL DESCRIBE THE PROPOSED METHODS TO PREVENT THE DISCHARGE OF SOLID MATERIALS, INCLUDING BUILDING MATERIAL INTO THE SURFACE WATER. THE PROPOSED METHODS SHALL INCLUDE AT LEAST THE FOLLOWING, UNLESS OTHERWISE APPROVED BY THE ENGINEER.

PROVIDE LITTER CONTROL AND COLLECTION WITHIN THE PROJECT LIMITS DURING CONSTRUCTION ACTIVITIES. DISPOSE OF ALL FERTILIZER OR OTHER CHEMICAL CONTAINERS ACCORDING TO

EPA STANDARD PRACTICES AS DETAILED BY THE MANUFACTURER. DISPOSE OF SOLID MATERIALS INCLUDING BUILDING AND CONSTRUCTION MATERIALS OFF THE PROJECT SITE BUT NOT IN SURFACE WATERS OR WETLANDS.

DISPOSE OR RECYCLE MATERIALS IN COMPLIANCE WITH ALL LOCAL, STATE AND FEDERAL REGULATION.

2. C.2 OFF-SITE VEHICLE TRACKING & DUST CONTROL IN THE SECTION 104 EROSION CONTROL PLAN, THE CONTRACTOR SHALL DESCRIBE THE PROPOSED METHODS FOR MINIMIZING OFFSITE VEHICLE TRACKING OF SEDIMENTS AND GENERATING DUST. THE PROPOSED METHODS SHALL INCLUDE AT LEAST THE FOLLOWING UNLESS OTHERWISE APPROVED BY THE **FNGINFFR**

COVER LOADED HAUL TRUCKS WITH TARPAULINS. REMOVE EXCESS DIRT FROM ROADS DAILY. STABILIZE CONSTRUCTION ENTRANCES ACCORDING TO DESIGN STANDARD 106. (CONSTRUCTION ENTRANCES ARE ALREADY STABILIZED FOR THIS PROJECT.)

2. C.3 STATE AND LOCAL REGULATIONS FOR WASTE DISPOSAL, SANITARY SEWER OR SEPTIC TANK REGULATIONS:

IN THE SECTION 104 EROSION CONTROL PLAN, THE CONTRACTOR SHALL DESCRIBE THE PROPOSED PROCEDURES TO COMPLY WITH THE APPLICABLE STATE AND LOCAL REGULATIONS FOR WASTE DISPOSAL AND SANITARY SEWER OR SEPTIC SYSTEMS, ALL SANITARY WASTE WILL BE COLLECTED FROM PORTABLE UNITS BY A LICENSE SANITARY WASTE MANAGEMENT CONTRACTOR AS REQUIRED BY STATE REGULATIONS.

2. C.4 FERTILIZERS OR PESTICIDES:

IN THE SECTION 104 EROSION CONTROL PLAN, THE CONTRACTOR SHALL DESCRIBE THE PROCEDURES FOR APPLYING FERTILIZERS, PESTICIDES AND HERBICIDES. THE PROPOSED PROCEDURES SHALL COMPLY WITH APPLICABLE SUBSECTIONS OF SECTION 570 OF THE SPECIFICATIONS. CONTAINERS WILL BE DISPOSED OF AS REQUIRED BY LOCAL, STATE AND FEDERAL REGULATIONS, RINSATE FROM APPLICATORS WILL BE DISPOSED OF PROPERLY. NOT POURED INTO THE LAKES, CANALS OR INLETS.
HERBICIDES AND PESTICIDES SHALL BE STORED ONSITE IN THEIR ORIGINAL CONTAINERS WITH PRODUCT LABEL INTACT. 2. C.5 TOXIC SUBSTANCES

IN THE SECTION 104 EROSION CONTROL PLAN, THE CONTRACTOR SHALL PROVIDE A LIST OF TOXIC SUBSTANCES THAT ARE LIKELY TO BE USED ON THE JOB AND PROVIDE A PLAN OF ADDRESSING THE GENERATION, APPLICATION, MIGRATION, STORAGE AND DISPOSAL OF THESE SUBSTANCES, ABSORBENT MATERIALS WILL BE KEPT IN THE VEHICLES TO HANDLE ACCIDENTAL SPILLS OR LEAKS FROM VEHICLES AND OTHER EQUIPMENT AND PLASTIC SHEETING SHALL BE AVAILABLE TO PROTECT CONTAMINATED AREAS FROM RAINFALL, THE PROPER AUTHORITIES AT FDOT AND/OR EMERGENCY UNITS SHALL BE CONTACTED SHOULD AN ACCIDENTAL SPILL OCCUR.

CONTRACTOR SHALL PROVIDE A PROJECT SPECIFIC HAZARDOUS MATERIALS SPILL CONTROL PLAN IN ORDER TO ADDRESS THE HANDLING OF HYDROCARBON AND HAZARDOUS MATERIALS

PETROLEUM PRODUCTS SHALL BE STORED IN COVERED AREAS WITH SECONDARY CONTAINMENT SURROUNDING CONTAINER.

TOXIC/HAZARDOUS MATERIALS EXPOSED DURING CONSTRUCTION ACTIVITIES SHALL BE HANDLED AS PER THE FDOT STANDARD SPECIFICATIONS FOR ROAD AND BRIDGE CONSTRUCTION.

2. D. PERMITS: FDEP NPDES PERMIT

THE CONTRACTOR SHALL APPLY TO THE FLORIDA DEPARTMENT OF ENVIRONMENTAL PROTECTION FOR THE NPDES GENERAL CONSTRUCTION PERMIT PRIOR TO CONSTRUCTION USING AND UPDATING (IF NEEDED) THE STORM WATER POLLUTION PREVENTION PLAN (SWPPP).

3.0 MAINTENANCE

IN THE SECTION 104 EROSION CONTROL PLAN, THE CONTRACTOR SHALL PROVIDE A PLAN FOR MAINTAINING ALL EROSION AND SEDIMENT CONTROLS THROUGHOUT CONSTRUCTION, THE MAINTENANCE PLAN SHALL AT A MINIMUM, COMPLY WITH THE FOLLOWING:

ALL EROSION CONTROL FEATURES WILL BE MAINTAINED TO FUNCTION AS DESCRIBED IN THE SWPPP AND THE FDOT STANDARDS. FILTER FABRIC: ROUTINELY REMOVE DIRT AND DEBRIS FROM THE FABRIC SO AS NOT TO IMPEDE WATER FLOW. TORN FABRICS WILL BE REPLACED IMMEDIATELY. SODDING REPAIR WASHOUTS AND BARE SPOTS IMMEDIATELY.
SILT FENCE: SILT FENCE WILL BE INSTALLED PER FDOT STANDARDS. TORN
OR BREACHED FENCE WILL BE REPAIRED IMMEDIATELY. SILT BUILD-UP CAUSING EXCESS PONDING WILL BE REMOVED AS NEEDED AND PRIOR TO THE FINAL REMOVAL OF THE SILT FENCE. BUFFER ZONES: STABILIZE BARE SPOTS.

4.0 INSPECTIONS

QUALIFIED PERSONNEL SHALL INSPECT THE FOLLOWING ITEMS AT LEAST ONCE EVERY SEVEN CALENDAR DAYS AND WITHIN 24 HOURS OF THE END OF A STORM THAT IS .50 INCHES OR GREATER. TO COMPLY, THE CONTRACTOR SHALL INSTALL AND MAINTAIN RAIN GAUGES AND RECORD THE DAILY RAINFALL. WHERE THE SITE HAS BEEN PERMANENTLY STABILIZED, INSPECTIONS SHALL BE CONDUCTED AT LEAST ONCE EVERY MONTH, THÉ CONTRACTOR SHALL ALSO ENSURE THAT CONTROLS INSTALLED IN THE FIELD AGREE WITH THE LATEST STORMWATER POLLUTION PREVENTION PLAN.

POINTS OF DISCHARGE TO SURFACE WATERS OR WETLANDS

POINTS OF DISCHARGE TO MUNICIPAL SEPARATE STORM SEWER SYSTEMS (INLET) DISTURBED AREAS OF THE SITE THAT HAVE NOT BEEN FINALLY STABILIZED AREAS USED FOR STORAGE OF MATERIALS THAT ARE EXPOSED TO PRECIPITATION

STRUCTURAL CONTROLS FOR EXAMPLE FILTER FABRIC AND SILT FENCE LOCATIONS HERE VEHICLES ENTER OR EXIT THE SITE (TRACKING) STORMWATER MANAGEMENT SYSTEMS

5.0 NON-STORMWATER DISCHARGES

IN THE SECTION 104 EROSION CONTROL PLAN, THE CONTRACTOR SHALL IDENTIFY ALL ANTICIPATED NON-STORMWATER DISCHARGES SUCH AS THOSE LISTED BELOW (EXCEPT FLOWS FROM FIRE FIGHTING ACTIVITIES). THE CONTRACTOR SHALL DESCRIBE THE PROPOSED MEASURES TO PREVENT POLLUTION OF THESE NON-STORMWATER DISCHARGES.

WATER FROM DUST CONTROL OPERATIONS EQUIPMENT WASHOUT

IF CONTAMINATED SOIL OR GROUNDWATER IS ENCOUNTERED DURING CONSTRUCTION, THE CONTRACTOR IS TO CEASE OPERATIONS IN THAT AREA. THE CONTRACTOR SHALL CONTACT TERRI NEWMAN, DISTRICT CONTAMINATION IMPACT COORDINATOR AT 386-961-7713.

REVISIONS DESCRIPTION DATE DESCRIPTION DATE

SCOTT CARTER, P.E. P.F. NO: 48930 PROSSER, INC 13901 SUTTON PARK DRIVE SOUTH, SUITE 200 JACKSONVILLE, FL 32224 CERTIFICATE OF AUTHORIZATION: 00004050

STATE OF FLORIDA DEPARTMENT OF TRANSPORTATION ROAD NO. COUNTY FINANCIAL PROJECT ID DUVAL SR 212 431962-1-52-01

STORM WATER POLLUTION PREVENTION PLAN

SHEET NO.

LD-51

DIGITALLY

P:\112\112041-01-SR 212 LANDSCAPE\CADD\CURRENT\43196213201\road

9:44:31 AM

- 1. NOTIFICATION OF LANE CLOSURES OR TEMPORARY DETOURS SHALL BE ACCOMPLISHED 14
 WORKING DAYS PRIOR TO CLOSURE, DETOUR OR MOT PHASE CHANGE BY SUBMITTING THE
 REQUIRED ELECTRONIC LANE CLOSURE FORM (HTTP://GIS.ATECTRANS.NET/LCIS/), SKETCHES,
 CALCULATIONS, AND OTHER DATA THROUGH THE ENGINEER TO THE DISTRICT TRAFFIC
 OPERATIONS OFFICE.
- 2. AT THE DISCRETION OF THE ENGINEER, IF A LANE CLOSURE CAUSES EXTENDED CONGESTION OR DELAY, THE CLOSED LANE(S) SHALL BE REOPENED UNTIL SUCH TIME THAT THE TRAFFIC FLOW HAS RETURNED TO AN ACCEPTABLE LEVEL, AT NO ADDITIONAL COST.
- 3. THE TRAFFIC AND TRAVEL WAYS SHALL NOT BE ALTERED TO CREATE A WORK ZONE UNTIL ALL LABOR AND MATERIAL IS AVAILABLE FOR THE CONSTRUCTION IN THAT AREA.
- 4. LANE CLOSURES SHALL OCCUR ONLY DURING NON-PEAK HOURS ON NON-EVENT DAYS/NIGHTS/WEEKENDS. PEAK HOURS ARE THE SAME TIME PERIOD 7 DAYS A WEEK.

FROM SAN PABLO ROAD TO PENMAN ROAD: EASTBOUND PEAK HOURS ARE 4:00 PM TO 7:00 PM; WESTBOUND PEAK HOURS ARE 6:30 AM TO 9:00 AM.
FROM PENMAN ROAD TO SOUTH 12TH STREET: PEAK HOURS ARE 6:30 AM TO 8:00 PM IN BOTH DIRECTIONS.

DAYTIME LANE CLOSURES ARE NOT ALLOWED DURING TOURIST SEASON FROM CHRISTMAS THROUGH EASTER. NO EXISTING LANES SHALL BE CLOSED ON SATURDAY, SUNDAY, OR ANY HOLIDAY. NO EXISTING LANES SHALL BE CLOSED DURING SPECIAL EVENTS AS DETERMINED BY THE ENGINEER.

5. PORTABLE CHANGEABLE MESSAGE SIGNS (PCMS) SHALL BE INSTALLED AT LEAST TWO WEEKS PRIOR TO BEGINNING CONSTRUCTION WITH THE MESSAGE(S) AS DIRECTED BY THE ENGINEER.

LOCATIO	ON OF B	OARDS :	SEE T	RAFFIC	CONTR	OL PLAN	VS
USED:	FROM TO	·		AT:	AM/P AM/P	M	
MESSAGE	PROGR	AMMED	BY:				
	<u>М</u> 	E W H	D 0 E	<u>I</u> <u>R</u> А	А К D	<i>N</i>	
TIMING							
MESSAGE MESSAGE							
				SSAGE S	SIGN (PCMS)	DET
				SSAGE S	SIGN (PCMS)	DET.
DURING	CONSTR	UCT I ON OARDS :	SEE T	RAFFIC	CONTRO	OL PLAN	
DURING LOCATIO	CONSTR	UCT I ON OARDS :	SEE T	RAFFIC	CONTRO	OL PLAN	
PORT AB DURING LOCATIO USED: MESSAGE	CONSTR ON OF B FROM TO	UCT I ON OARDS : 	SEE T	RAFFIC AT: AT:	CONTRO	OL PLAN	
DURING LOCATIO USED:	CONSTR ON OF B FROM TO	UCT I ON OARDS : 	SEE T	RAFFIC AT:	CONTRO	OL PLAN	
DURING LOCATIO USED:	CONSTR ON OF B FROM TO	UCT I ON OARDS : 	SEE T	RAFFIC AT: AT:	CONTRO	OL PLAN	
DURING LOCATIO USED:	CONSTR ON OF B FROM TO	UCT I ON OARDS : 	SEE T	RAFFIC AT:	CONTRO	OL PLAN	
DURING LOCATIO USED:	CONSTR ON OF B FROM TO	UCT I ON OARDS : 	SEE T	RAFFIC AT: AT: 5AGE 1	CONTRO	OL PLAN	
DURING LOCATIO USED:	CONSTR ON OF B FROM TO	UCT I ON OARDS : 	SEE T	RAFFIC AT: AT: 5AGE 1	CONTRO AM/F AM/F	OL PLAN	
DURING LOCATIO USED:	CONSTR ON OF B FROM TO	UCT I ON OARDS : 	SEE T	RAFFIC AT: AT: SAGE 1 R I	CONTRO AM/F AM/F	OL PLAN	
DURING LOCATIO USED:	CONSTR ON OF B FROM TO	UCT I ON OARDS : 	SEE T	RAFFIC AT: AT: SAGE 1 R I	CONTRO AM/F AM/F	OL PLAN	

REVISIONS				SCOTT CARTER, P.E.	STATE OF FLORIDA		
DATE	DESCRIPTION	DATE	DESCRIPTION	P.E. NO.: 48930	DEPARTMENT OF TRANSPORTATIO		
				PROSSER, INC.			
				13901 SUTTON PARK DRIVE SOUTH, SUITE 200	ROAD NO.	COUNTY	FINANCIAL PROJECT ID
				JACKSONVILLE, FL 32224 CERTIFICATE OF AUTHORIZATION: 00004050	SR 212	DUVAL	431962-1-52-01

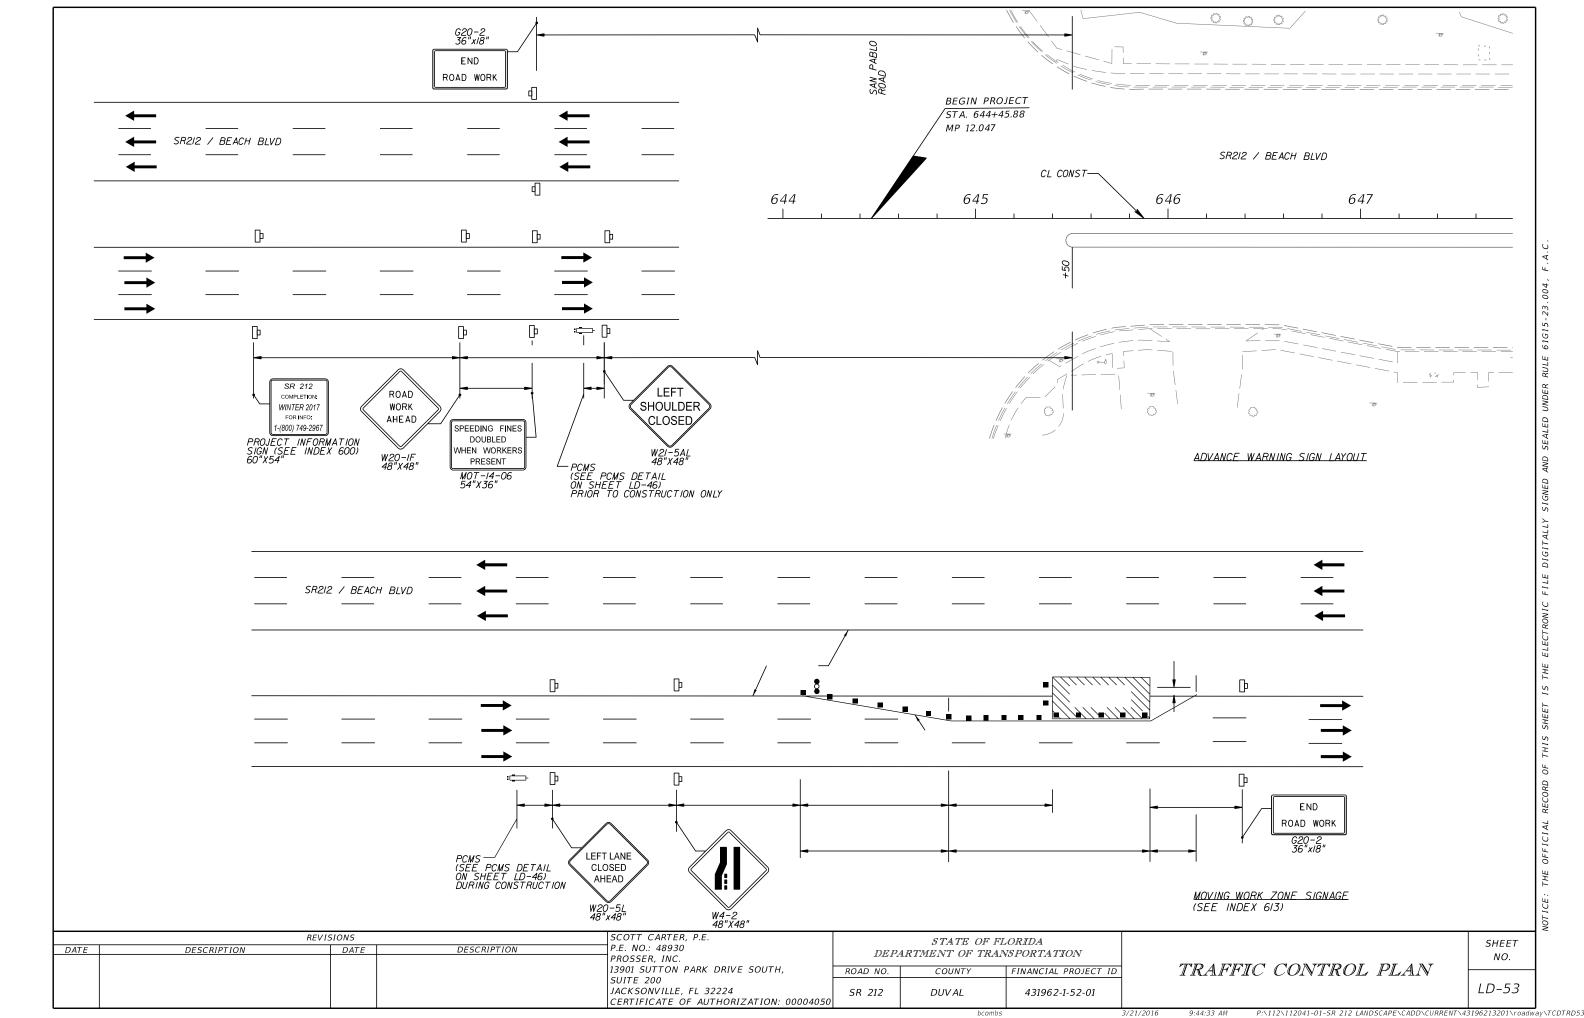
TRAFFIC CONTROL
PLAN

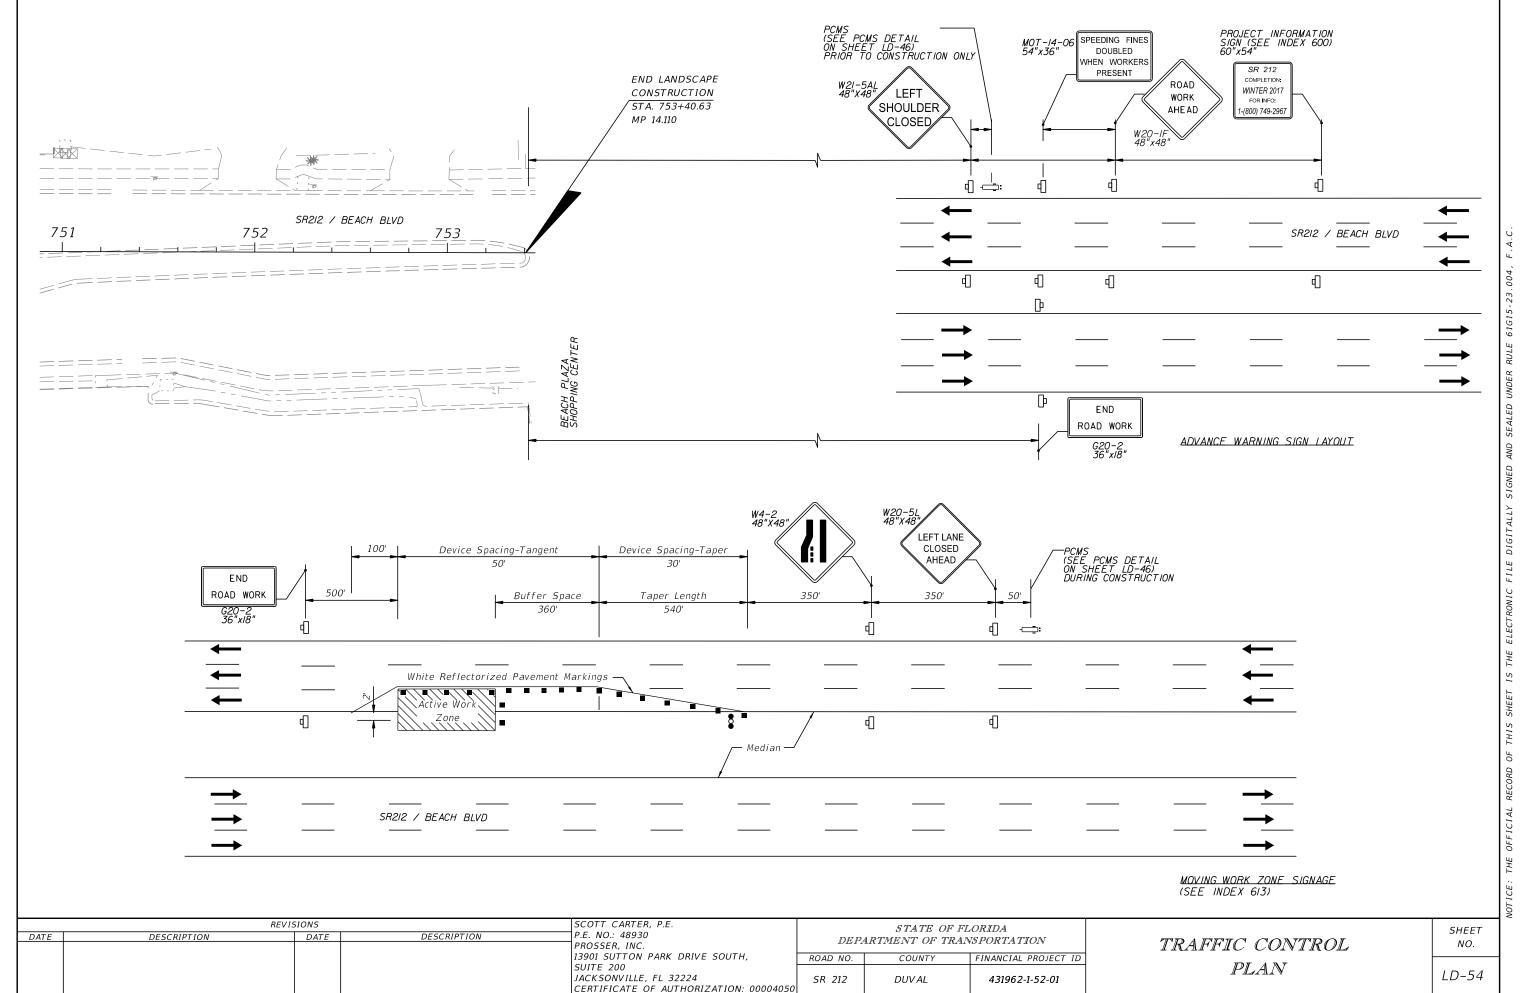
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ACTIVITY	MINIMUM CYCLES/YR	DESCRIPTION
MOWING	12	MOW GRASS FROM R/W TO R/W FOR THE ENTIRE PROJECT LIMITS AND AS NOTED ON THE LANDSCAPE PLANS.
WATERING /IRRIGATION	AS REQUIRED	MONITOR IRRIGATION SYSTEM TO ENSURE PROPER OPERATION AND SCHEDULING TO PROVIDE OPTIMUM GROWING CONDITIONS AND TO MAINTAIN PLANT QUALITY. SUPPLY HAND-WATERING IF IRRIGATION SYSTEM IS NOT OPERATIONAL, WATER SOURCE SHALL BE APPROVED BY THE ENGINEER, OBTAIN WATER TEST AND SUBMIT RESULTS TO ENGINEER FOR APPROVAL, PRIOR TO APPLYING HAND WATERING.
LITTER REMOVAL	12	PERFORM LITTER REMOVAL CYCLE PRIOR TO EACH MOWING CYCLE. LITTER PICK-UP SHALL ALSO INCLUDE REMOVAL OF FALLEN BRANCHES AND PALM FRONDS.
EDGING	12	PERFORM EDGING CYCLE AT EACH MOWING CYCLE. MECHANICAL EDGING SHALL BE USED FOR TURF ADJACENT TO WALKWAY, PAVEMENT, CURB AND CURBED MEDIANS. CHEMICAL HERBICIDE EDGING CAN BE USED ON TREE RINGS AND PLANTING BEDS, TAKING PRECAUTIONS TO AVOID OVERSPRAY ONTO LANDSCAPE PLANTS.
WEEDING	12	MAINTAIN PLANTING BEDS AND TREE RINGS WEED FREE AT ALL TIMES. AT A MINIMUM, PERFORM WEEDING BY GLYPHOSATE POST-EMERGENT CHEMICAL APPLICATION WITH PIGMENTED TRACER. HERBICIDE APPLICATIONS SHALL INCLUDE 'SEDGE' SPECIFIC POST-EMERGENT HERBICIDE, APPLIED PER MANUFACTURE'S SPECIFICATIONS. WEEDS ABOVE 12 INCHES SHALL BE HAND REMOVED, PRIOR TO HERBICIDE APPLICATION.
FERTILIZATION	1	ALL PLANT MATERIAL AND PALMS SHALL BE FERTILIZED WITH A 12 MONTH SLOW RELEASE TOP DRESSING FERTILIZER WITH A MINOR ELEMENT PACKAGE TO INCLUDE (BUT NOT LIMITED TO) CALCIUM, MAGNESIUM, SULFUR, IRON, COPPER, MANGANESE, MOLYBDENUM, ZINC AND BORON.
		ALL PLANT MATERIALS SHALL BE FERTILIZED AT THE TIME OF PLANTING, YEARLY DURING THE ESTABLISHMENT PERIOD, AND 30 DAYS PRIOR TO COMPLETION OF THE ESTABLISHMENT PERIOD. NOTIFY THE ENGINEER IN WRITING 48 HOURS IN ADVANCE OF ALL FERTILIZER APPLICATIONS.
PLANT REPLACEMENT	MONTHLY	MONITOR PLANT MATERIALS TO ENSURE THE MINIMUM ACCEPTABLE MAINTENANCE STANDARDS ARE BEING MET. PLANT MATERIAL THAT IS DISEASED OR FALLS BELOW THE MINIMUM STANDARDS SHALL BE REMOVED AND REPLACED. REPLACE PLANTS WITH THE SAME GRADE, SIZE AND SPECIFICATION AS ORIGINALLY PROVIDED FOR IN THE PROJECT PLANS AND SPECIFICATIONS.
CHEMICAL APPLICATIONS	MONTHLY	MONITOR PLANT MATERIALS FOR PEST INFESTATION AND DISEASE TO INCLUDE BUT NOT LIMITED TO INSECTS, GRUBS, MITES, MOLD, ETC. APPLY FUNGICIDE AND PESTICIDES PER MANUFACTURES RECOMMENDATIONS. SUBMIT DOCUMENTATION IN WRITING TO THE ENGINEER FOR EACH CHEMICAL TYPE APPLIED, RATES OF APPLICATIONS, LOCATIONS, DATES OF APPLICATION AND APPLICATOR'S NAME AND LICENSE INFORMATION.
WATER SAUCERS, AND STAKING	AS REQUIRED	MONITOR AND REPAIR WATER SAUCERS THROUGHOUT THE ESTABLISHMENT PERIOD. MONITOR STAKING THROUGHOUT THE ESTABLISHMENT PERIOD TO MAINTAIN TREES VERTICALLY PLUMB, REPAIR STAKES/GUYING AS NECESSARY.
MULCH	2	MAINTAIN MINIMUM OF THREE (3) INCHES COMPACTED DEPTH OF MULCH MATERIALS WITHIN ALL PLANTING BEDS AND TREE RINGS PER THE PROJECT PLANS. REPLENISH BETWEEN MULCH APPLICATIONS TO MAINTAIN THREE INCH DEPTH. PERFORM FULL MULCH APPLICATION UPON PLANT INSTALLATION.
PRUNING	MONTHLY	TREES: PRUNE AT INSTALLATION TO MEET FL#1 REQUIREMENTS, TO MAINTAIN HORIZONTAL CLEARANCE (PER FDOT DESIGN STANDARDS) AND TO REMOVE ALL SUCKERS, DEAD, DISEASED OR BROKEN BRANCHES.
		PALMS: PRUNE AT INSTALLATION TO MEET FL#1 REQUIREMENTS, REMOVE BROKEN OR DEAD FRONDS AND FLOWER/SEED STALKS AND AS NECESSARY THROUGHOUT THE ESTABLISHMENT PERIOD.
		MAINTAIN VERTICAL CLEARANCE SO THAT THERE ARE NO ENCROACHMENT OF TREES LIMBS, PALM FRONDS OR OTHER VEGETATION ABOVE THE ROADWAY SURFACE. REMOVE AND/OR PRUNE VEGETATION OR PARTS OF VEGETATION THAT PRESENT A VISIBLE HAZARD TO THOSE USING THE ROADWAY.

REVISIONS			SHAWN BLISS, R.L.A.	STATE OF FLORIDA				
DATE	DESCRIPTION	DATE	DESCRIPTION	R.L.A. NO.: 1548	DEPARTMENT OF TRANSPORTA			
				PROSSER, INC.			11101 01(1111101)	
				13901 SUTTON PARK DRIVE SOUTH,	ROAD NO.	COUNTY	FINANCIAL PROJECT ID	
				SUITE 200				
				JACKSONVILLE, FL 32224	SR 212	DUVAL	431962-1-52-01	
				CEPTIEICATE OF AUTHORIZATION, 00004050				

MAINTENANCE PLAN

SHEET NO.

LD-55